MONTEREY PINES APARTMENTS

816 CAROLINE COURT, COROLLA, CURRITUCK COUNTY NORTH CAROLINA

GENERAL NOTES

1. THE ARCHITECT SHALL NOT BE RESPONSIBLE FOR ANY ERROR, OMISSION, DEFECT OR DEFICIENCY IN THE CONTRACT DOCUMENTS ("ERROR") PREPARED BY THE ARCHITECT OR ITS CONSULTANTS WHICH IN ANY WAY IMPACTS THE SCHEDULE OF THE PROJECT, RESULTS IN A LACK OF COORDINATION AMONG THE CONTRACT DOCUMENTS, DELAYS THE COMPLETION OF THE PROJECT OR WHICH IN ANY OTHER WAY CAUSES ANY DAMAGE OR LOSS TO THE OWNER, CONTRACTOR, SUBCONTRACTORS, OR OTHER ENTITY INVOLVED IN THE PROJECT UNLESS: (1) THE ARCHITECT IS PROMPTLY NOTIFIED OF SUCH ERROR, IN ANY EVENT WITHIN 14 DAYS OF THE DATE SUCH ERROR WAS DISCOVERED OR COULD REASONABLY HAVE BEEN DISCOVERED; AND (2) THE ARCHITECT IS GIVEN OPPORTUNITY AT THE TIME OF DISCOVERY TO ADDRESS SUCH ERROR, AND IF APPROPRIATE, TAKE SUCH STEPS AS ARE NECESSARY TO CORRECT AND RESOLVE IT. FAILURE TO COMPLY WITH THE PROVISIONS OF THIS PARAGRAPH SHALL CONSTITUTE A WAIVER OF ANY CLAIM FOR DAMAGES, OR A RIGHT TO OFFSET AGAINST THE ARCHITECT BY OWNER, CONTRACTOR OR OTHERS AND SHALL IN NO EVENT CAUSE OR ALLOW A REDUCTION IN THE FEES OTHERWISE DUE THE ARCHITECT FOR SERVICES PROVIDED ON THE PROJECT.

2. THE ARCHITECT IS NOT RESPONSIBLE FOR ANY DAMAGES CAUSED BY OMISSIONS OR INACCURACIES OF SITE INFORMATION. INCLUDING BUT NOT LIMITED TO EASEMENTS, SETBACKS, METES AND BOUNDS, TITLE OWNERSHIP, FLOOD ZONE DESIGNATIONS AND CAMA REQUIREMENTS, PROVIDED BY THE CLIENT, TAX MAPS, SURVEYORS AND/OR ENGINEERS.

3. ALL PARTIES ACKNOWLEDGE AND AGREE THAT ALL DESIGNS ARE THE SOLE PROPERTY OF THE ARCHITECT. THIS AGREEMENT IS FOR A SINGLE LICENSED USE OF PLANS.
ANY USE OF PLANS, OTHER THAN THE LIMITED LICENCE PROVIDED IN THIS PARAGRAPH IS NOT PERMITTED WITHOUT PRIOR WRITTEN CONSENT OF ARCHITECT. CLIENT SHALL
PAY ARCHITECT FOR ANY REVISION WORK MADE TO DRAWINGS FOR REUSE AT AN HOURLY RATE DETERMINED BY THE ARCHITECT. ARCHITECT SHALL HAVE THE RIGHT TO
INCLUDE PHOTOGRAPHIC OR ARTISTIC REPRESENTATIONS OF THE PROJECT AMONG THE ARCHITECT'S PROMOTIONAL AND PROFESSIONAL MATERIALS (INCLUDING WITHOUT
LIMITATION ARCHITECT'S WEBSITE).

4. THE ARCHITECT IS NOT RESPONSIBLE FOR MEANS, METHODS OR TECHNIQUES IN THE CONSTRUCTION OF THIS PROJECT.

5. GENERAL CONTRACTOR IS SOLELY RESPONSIBLE FOR THE PROPER INSTALLATION OF ALL INSULATION. INSULATION MUST BE CONTINUOUS AT THE BUILDING ENVELOPE, G.C. TO BLOCK AS REQ'D FOR INSTALLATION.

ABBREVIATIONS




LIST OF DRAWINGS



MATERIALS

KEY BUBBLE

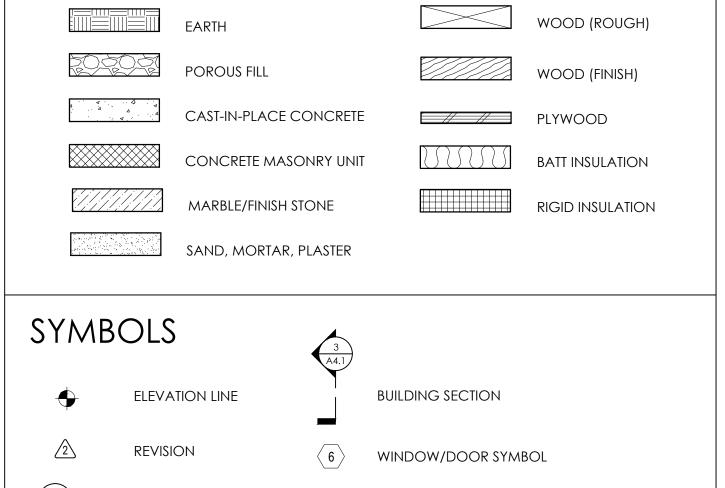


VICINITY MAP



SITE DIAGRAM

SCALE

NOT TO SCALE
ORIGINAL DRAWING PROVIDED TO ARCHITECT BY CONTRACTOR
NOT FOR RECORDATION, CONVEYANCE, OR STAKE-OUT.

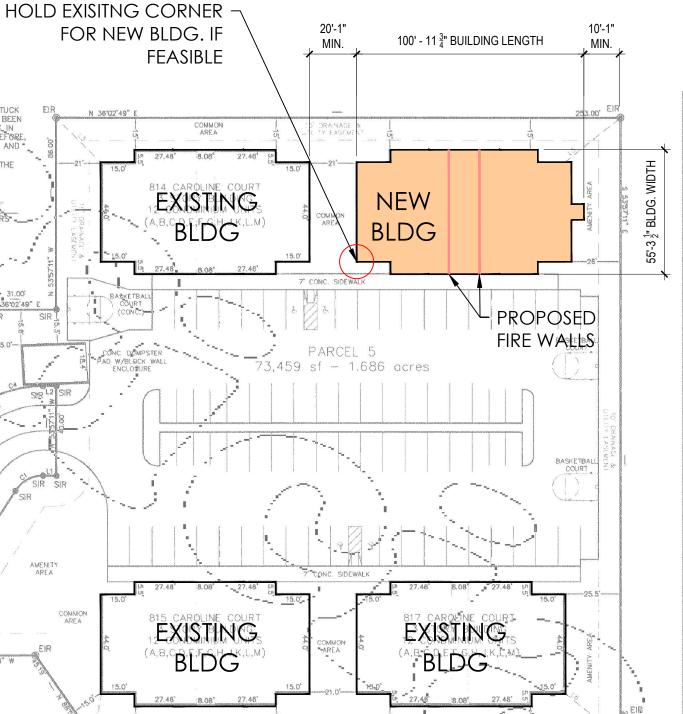

BEACON ARCHITECTURE + DESIGN, P.L.L.C. P.O. BOX 1827 KITTY HAWK, NC 27949 PH: (252) 441-6767, FAX (252) 261-6045



TO DO SO WILL VOID HOUSE ENGINEERING P.C.'S LIABILITY

PROJECT NAME:

MONTERAY PINES

816 Caroline Ct. Corolla, NC

	REVISIONS:	DATE:
	ISSUED FOR CONST.	3/3/23
	REVISION #1	3 / 20 / 23

DRAWING NAME:

TITLE SHEET

ISSUED FOR CONSTRUCTION

DRAWN BY:	CN
DATE:	3 /20/ 23
SCALE:	





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PROJECT INFORMATION NAME OF PROJECT MONTEREY PINES CONDOMINUM BUILDING

816 CAROLINE COURT, COROLLA, NORTH CAROLINA ADDRESS

PROPOSED USE RESIDENTIAL (R-2)

OWNER/AGENT SEASIDE MANAGEMENT- JEFF SHIELDS CURRITUCK COUNTY CODE ENFORCEMENT

A RESIDENTIAL MULTI-FAMILY APARTMENT BUILDING WITHIN THE MONTEREY PINES SUBDIVISION. PROJECT SUMMARY

THE ORIGINAL STRUCTURE HAD A FIRE AND WAS DEMOLISHED. THIS NEW BUILDING USES SIMILAR PLAN ELEMENTS BUT MEETS CURRENT BUILDING CODES. THE BUILDING HAS 12 UNITS WITH EACH

ONE OWNED SEPARATELY AS A CONDOMINIMUM.

LEAD PROFESSIONAL BEACON ARCHITECTURE + DESIGN, P.L.L.C.

TELEPHONE # CHRISTOPHER NASON BEACON ARCHITECTURE + DESIGN, P.L.L.C. (252) 441-6767 ARCHITECTURAL HOUSE ENGINEERING **RICK HOUSE** CIVIL (252) 261-8253 **RICK HOUSE** STRUCTURAL HOUSE ENGINEERING (252) 261-8253 **ELECTRICAL** PACE COLLABORATIVE JAMES E. BARKLEY JR. (757) 499-7223 FIRE ALARM PACE COLLABORATIVE JAMES E. BARKLEY JR. (757) 499-7223 PLUMBING PACE COLLABORATIVE TAYLOR C. JONES (757) 499-7223 TAYLOR C. JONES MECHANICAL PACE COLLABORATIVE (757) 499-7223 SPRINKLER TBD- DEFERRED SUBMITTAL POST PERMIT TBD (757) 499-7223 TRUSSES TBD- BY TRUSS MANUFACTURER POST PERMIT TBD TBD

BUILDING CODES 2018 NORTH CAROLINA BUILDING CODE

ICC/ANSI A117.1- 2009

PROJECT DATA **CONSTRUCTION TYPE-**V-B YES-NFPA 13r SPRINKLERS-

STANDPIPES-NO FIRE DISTRICT-NO NO MEZZANINE-

BUILDING AREAS-1ST FLOOR ENCLOSED = 4,174 SF 2ND FLOOR ENCLOSED = 4,136 SF 3RD FLOOR ENCLOSED = 4,136 SF

13r SPRINKLER SYSTEM REQUIRED AND PROVIDED <u>SPRINKLERS</u>

SPRINKLER PROTECTION SHALL BE PROVIDED FOR EXTERIOR BALCONIES, DECKS AND GROUND FLOOR PATIOS OF DWELLING UNITS WHERE THE BUILDING IS OF TYPE V CONSTRUCTION. SIDEWALL SPRINKLERS THAT ARE USED TO PROTECT SUCH AREAS SHALL BE PERMITTED TO BE LOCATED SUCH THAT THEIR DEFLECTORS ARE WITHIN 1 INCH TO 6 INCHES BELOW STRUCTURAL MEMBERS AND A MAXIMUM DISTANCE OF 14 INCHES BELOW THE DECK OF THE EXTERIOR BALCONIES AND DECKS THAT ARE CONSTRUCTED OF OPEN WOOD JOIST CONSTRUCTION (SECTION 903.2.8).

12,446 SF

ALLOWABLE AREA PRIMARY OCCUPANCY

RESIDENTIAL (R-2) **DESCRIPTION AND USE-**CONDOMINIMUM APARTMENTS

ALLOWABLE AREA-7,000 SF PER STORY (PER TABLE 506.2) W/REQUIRED SPRINKLERS* **ACTUAL BUILDING AREA-**4,174 SF MAXIMUM ENCLOSED AREA- BUILDING COMPLIES.

*AREA FOR FRONTAGE IS NOT REQUIRED TO COMPLY WITH CODE

TBD

ALLOWABLE HEIGHT

ALLOWABLE BUILDING HEIGHT-60 FEET WITH A NFPA 13R SPRINKLER SYSTEM (PER TABLE 504.3) ALLOWABLE NUMBER OF STORIES-3 STORIES WITH A NFPA 13R SPRINKLER SYSTEM (PER TABLE 504.4)

ACTUAL BUILDING HEIGHT-+/- 39'-4" FROM FINISHED GRADE TO PEAK OF ROOF

ELEVATOR **REQUIREMENTS**

BUILDING IS NOT REQUIRED TO HAVE AN ELEVATOR SINCE BUILDING IS ONLY 3 STORIES (SEE SECTION 1009.2.1). THE FIRST FLOOR IS ON AN ACCESSIBLE ROUTE (SLAB ON GRADE) AND SHALL CONTAIN THE REQUIRED TYPE B UNITS.

TYPE B UNITS SHALL BE REQURED ON THE WHOLE FIRST FLOOR WHERE THERE ARE OVER 4 UNITS IN THE BUILDING.

TYPE A UNITS ARE NOT REQUIRED BY CODE SINCE THEE ARE LESS THAN 15 UNITS IN THE BUILDING.

ACCESSIBLE TYPE UNITS ARE NOT REQUIRED FOR CONDOMINIMUMS. (COMPLIANCE PATH= 1104.4 EX.2 TO 1107.4 EX.3&4) TO 1107.6.2.2.1 FOR TYPE A AND B REQUIREMENTS. 1107.6.2.3.1 EX. 4 FOR

ACCESSIBLE UNIT REQUIREMENTS.

LIFE SAFETY SYSTEM EMERGENCY LIGHTING REQUIRED AT EXTERIOR STAIRCASES AND COMMON DECK REQUIREMENTS EXIT SIGNS REQUIRED AT EXTERIOR STAIRCASES AND COMMON DECK

FIRE ALARM REQUIRED

SMOKE DETECTION SYSTEMS REQUIRED PANIC HARDWARE NOT REQUIRED

NOT REQUIRED AT SLEEPING ROOMS BUT PROVIDED (SECTION 1030.1) **EGRESS WINDOWS**

REQUIREMENTS

<u>UNIT TYPES</u>

FIRE SEPARATION DISTANCE 10 FEET MIN. BETWEEN BUILDINGS SEE ORIGINAL AS-BUILT DRAWING ACTUAL DISTANCE BETWEEN BUILDINGS EXCEEDS 20'/2= 10' MINIMUM.

THUS NO EXTERIOR FIRE RATING REQUIRED PER SECTION 602.

FOR BUILDINGS ON THE SAME LOT SEE SECTION 705.3. FOR MORE INFO. MINIMUM PROJECTION REQUIREMENTS WOULD NOT APPLY PER

SECTION 705.2 EXCEPTION 2.

BEARING WALLS- EXTERIOR O HR REQUIRED (SEE TABLE 601)

NON-BEARING WALLS- EXTERIOR O HR REQUIRED (SEE TABLE 601) BEARING WALLS- INTERIOR

O HR REQUIRED AT DWELLING UNITS IN TYPE VB CONSTRUCTION SIMILAR FOR THE CONSTRUCTION SUPPORTING THE HORIZONTAL ASSEMBLY (SEE 711.2.3 EXCEPTION 2 FOR SUPPORTING CONSTRUCTION AND TABLE 601)

NON-BEARING WALLS- INTERIOR O HR REQUIRED (SEE TABLE 601)

0-1/2 HR MIN. AT HORIZONTAL ASSEMBLY PENETRATION TO MATCH FLOOR RATING. FLOOR CONSTRUCTION AT FLAT UNITS 1/2 HR MIN. REQUIRED WITH NFPA 13r SPRINKLER SYSTEM (SEE 711.2.4.3)- 1 HOUR PROVIDED 1/2 HR REQUIRED AT HORIZONTAL ASSEMBLY (SEE 711.2.4.3)- 1 HOUR PROVIDED

2ND FLOOR CEILING/ROOF INTERIOR FIRE PARTITIONS BETWEEN DWELLING UNITS

1/2 HR MIN. REQUIRED WITH NFPA13r SPRINKLER SYSTEM (SEE 708.3)- 2 HOUR FIRE WALL BREEZEWAY WALLS PROVIDED TO COMPLY WITH ISO CALCULATIONS

NO LIMIT AT FIRE SEPARATION DISTANCES OVER 30 FEET.

MAXIMUM AREA OF EXTERIOR 45% MAXIMUM FOR UNPROTECTED SPRINKLERED BUILDIINGS 10-15 FEET 75% MAXIMUM FOR UNPROTECTED SPRINKLERED BUILDIINGS 15-20 FEET WALL OPENINGS BASED ON FIRE SEPARATION DISTANCE NO LIMIT FOR UNPROTECTED SPRINKLERED BUILDIINGS BEYOND 20 FEET

OPENINGS BASED UPON FIRE

CURRENT DESIGNS DO NOT EXCEED 23% GLAZING FOR EXTERIOR FACADES. BUILDING COMPLIES AS IT IS LESS THAN 45% FOR EXTERIOR FACADES.

AT BREEZEWAY FIRE WALL, ALL OPENINGS DOORS/FRAMES WILL BE FIRE RATED TO MEET

1/2 HR MIN. REQUIRED WITH NFPA 13r SPRINKLER SYSTEM (SEE 708.3)- 1 HOUR PROVIDED

TABLE 716.5.

APPENDIX B CODE ANALYSIS

SCALE:N.T.S.

ATTIC FIREBLOCKING OR DRAFTSTOPPING IS NOT REQUIRED AT THE PARTITION LINE IN GROUP DRAFTSTOPPING

R2- BUILDINGS THAT DO NOT EXCEED 4 STORIES IN HEIGHT. PROVIDED THE ATTIC SPACE IS SUBDIVIDED INTO

AREAS NOT EXCEEDING 3000 SF OR ABOVE EVERY TWO DWELLING UNITS, WHICHEVER IS SMALLER. (SEE 708.4 EXCEPTION 4) ATTIC FIREBLOCKING OR DRAFTSTOPPING HAS BEEN PROVIDED BY THE ARCHITECT AT EVERY DWELLING UNIT (INCLUDING

BETWEEN TRUSSED FLOORS AT TENANT DEMISING WALLS.

<u>INTERIOR FINISHES</u> ALL SPACES WITHIN A R-2 SPRINKLERED USE ARE TO BE CLASS C. FLAME SPREAD INDEX = 76-200.

SMOKE DEVELOPED INDEX = 0-450. SEE CODE SECTIONS 803 AND TABLE 803.13.

DOOR THRESHOLD THE ENTRY DOOR TO THE FIRST FLOOR TYPE B UNITS SHALL HAVE ADA THRESHOLDS AT TYPE B UNITS. EXTERIOR DECK OR PATIOS (IMPERVIOUS SURFACE) AT THESE TYPE UNITS SHALL NOT HAVE A THRESHOLD MORE THAN 4" BELOW THE FINISHED

FLOOR LEVEL. UPPER FLOOR UNITS MAY HAVE A STEP DOWN AS THEY DO NOT HAVE TO BE COMPLIANT.

EXIT REQUIREMENTS NUMBER AND ARRANGEMENT OF EXITS

FLOOR, ROOM OR SPACE	MIN. NUMB	min. Number of exits		PATH OF TRAVEL
DESIGNATION	REQUIRED	SHOWN	ALLOWABLE	ACTUAL
DWELLING UNIT 1	1	1	125'	+/- 68'-0" MAX.
DWELLING UNIT 2	1	1	125'	+/- 88'-9" MAX.
DWELLING UNIT 3	1	1	125'	+/- 62'-0" MAX.
DWELLING UNIT 4	1	1	125'	+/- 88'-2" MAX.
DWELLING UNIT 5	1	1	125'	+/- 65'-4" MAX.
DWELLING UNIT 6	1	1	125'	+/- 93'-10" MAX.
DWELLING UNIT 7	1	1	125'	+/- 68'-6" MAX.
DWELLING UNIT 8	1	1	125'	+/- 91'-6" MAX.
DWELLING UNIT 9	1	1	125'	+/- 112'-4" MAX.
DWELLING UNIT 10	1	1	125'	+/- 83'-6" MAX.
DWELLING UNIT 11	1	1	125'	+/- 111'-6" MAX.
DWELLING UNIT 12	1	1	125'	+/- 92'-9" MAX.

1. EACH DWELLING UNIT IS ONLY REQUIRED TO HAVE ONE MEANS OF EGRESS PER SECTION (1006.2.1 EX 1). WITH AN AUTOMATIC SPRINKLER SYSTEM AND AN OCCUPANT LOAD OF LESS THAN 20 WITHIN THE DWELLING UNIT.

2. THE COMMON PATH OF TRAVEL DOES NOT TO EXCEED VALUES ABOVE FOR R-2 USES WITH AN NFPA 13r SPRINKLER SYSTEM.

3. THE OCCUPANT LOAD FOR EACH DWELLING UNIT DOES NOT EXCEED 10 PEOPLE (TABLE 1006.2.1). 4. FOR STORIES WITH ONE EXIT OR ACCES FOR R-2 OCCUPANCIES, PROPOSSED NUMBER OF DWELLING UNIT PER FLOOR DOES NOT

EXCEED 4 PER FLOOR (TABLE 1006.3.2(1). **FXIT/FXIT ACCESS**

EXIT WIDTH (3 STORY)- NOTE ALL DWELLING UNITS ARE MEASURED FROM CL OF TENANT DEMISING WALL AND FRONT & BACK STUD FACE

FLOOR, ROOM OR	(a)	(b)		EGRESS COMPONENTS	REQUIRED	STAIRWAYS (IN./OCC.)	REQUIRED	ACTUAL WIDTH
SPACE DESIGNATION	AREA	AREA/OC.	OCC.S	(IN./OCC.)	WIDTH	W/SPRINKLERS	WIDTH	SHOWN ON PLANS
DWELLING UNIT 1	1,034 G	200 G	5.1	0.15	0.7"	N/A- SLAB O	N GRADE	36" MIN. (WITHIN UNIT)*
DWELLING UNIT 2	1,034 G	200 G	5.1	0.15	0.7"	N/A- SLAB O	N GRADE	36" MIN. (WITHIN UNIT)*
DWELLING UNIT 3	1,034 G	200 G	5.1	0.15	0.7"	N/A- SLAB O	N GRADE	36" MIN. (WITHIN UNIT)*
DWELLING UNIT 4	1,034 G	200 G	5.1	0.15	0.7"	N/A- SLAB O	N GRADE	36" MIN. (WITHIN UNIT)*
SPRINKLER RISER RM.	39 G	500 G	0.1	0.15	0.1"	N/A- SLAB O	N GRADE	32" MIN. CLR. AT DOOR
1ST FLOOR TOTAL			20.5		2.9"			36" MIN. (WITHIN UNIT)*
DWELLING UNIT 5	1,034 G	200 G	5.1	0.15	0.7"	0.20	1.0"	
DWELLING UNIT 6	1,034 G	200 G	5.1	0.15	0.7"	0.20	1.0"	36" MIN. (WITHIN UNIT)*
DWELLING UNIT 7	1,034 G	200 G	5.1	0.15	0.7"	0.20	1.0"	36" MIN. (WITHIN UNIT)*
DWELLING UNIT 8	1,034 G	200 G	5.1	0.15	0.7"	0.20	1.0"	36" MIN. (WITHIN UNIT)*
2ND FLOOR TOTAL			20.4		2.8"		4.0"	
DWELLING UNIT 9	1,034 G	200 G	5.1	0.15	0.7"	0.20	1.0"	36" MIN. (WITHIN UNIT)*
DWELLING UNIT 10	1,034 G	200 G	5.1	0.15	0.7"	0.20	1.0"	36" MIN. (WITHIN UNIT)*
DWELLING UNIT 11	1,034 G	200 G	5.1	0.15	0.7"	0.20	1.0"	36" MIN. (WITHIN UNIT)*
DWELLING UNIT 12	1,034 G	200 G	5.1	0.15	0.7"	0.20	1.0"	
3RD FLOOR TOTAL			20.4		2.8"		4.0"	
BUILDING TOTAL			61.3 (62	OCCUPAN	TS) 8.5"		8.0"	48" MIN. (AT EXT. STAIRS)

*HALLWAY WIDTH WITHIN A DWELLING UNIT MUST BE 36" MINIMUM FINISHED CLEAR.

PLUMBING FIXTURE REQUIREMENTS


DECIDENTIAL	CLIDANICV		CLOSETS	LAVATORIES		LAVATORIES		LAVATORIES		LAVATORIES		BATH TUBS OR	DRINKING	OTHER
RESIDENTIAL OC	RESIDENTIAL OCCUPANCY	MALE	FEMALE	MALE	FEMALE	SHOWERS	FOUNTAINS	1 KITCHEN						
REQUIRED FIXTU	JRES	1 PER DWE	LLING UNIT	1 PER DWE	LLING UNIT	1	N/A	SINK PER UNIT						
PROVIDED FIXTU	JRES	1 MIN	IMUM	1 MIN	IMUM	1 MIN.	N/A	1 Wash/dry per unit						

ISO FIRE FLOW NOTE: FOR THE ISO CALCULATIONS, EACH SIDE OF THE BREEZEWAY FLOORS SHALL BE CONSIDERED SEPARATE BUILDINGS PER CHAPTER 5 OF THE ISO GUIDE FOR DETERMINATION OF FIRE FLOW (EDITION 06-20140. SEE CHAPTER 5 FOR REQUIREMENTS. THE ARCHITECT HAS PROVIDED FIRE FLOW CALCULATIONS TO CURRITUCK COUNTY FOR REVIEW AND THEY HAVE BEEN APPROVED.





TO DO SO WILL VOID HOUSE ENGINEERING, P.C.'S LIABILITY.

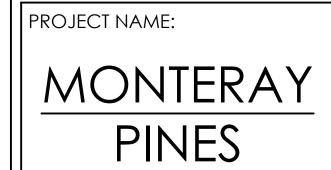


816 Caroline Ct Corolla, NC

REVISIONS:	DATE:
ISSUED FOR CONST.	3 / 3 / 23
REVISION #1	3 / 20 / 23

DRAWING NAME: APPENDIX B **CODE ANALYSIS**

ISSUED FOR CONSTRUCTION


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SCALE:	VARIES

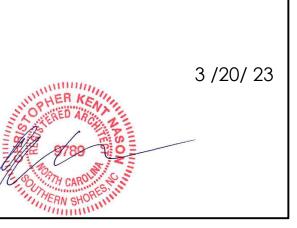

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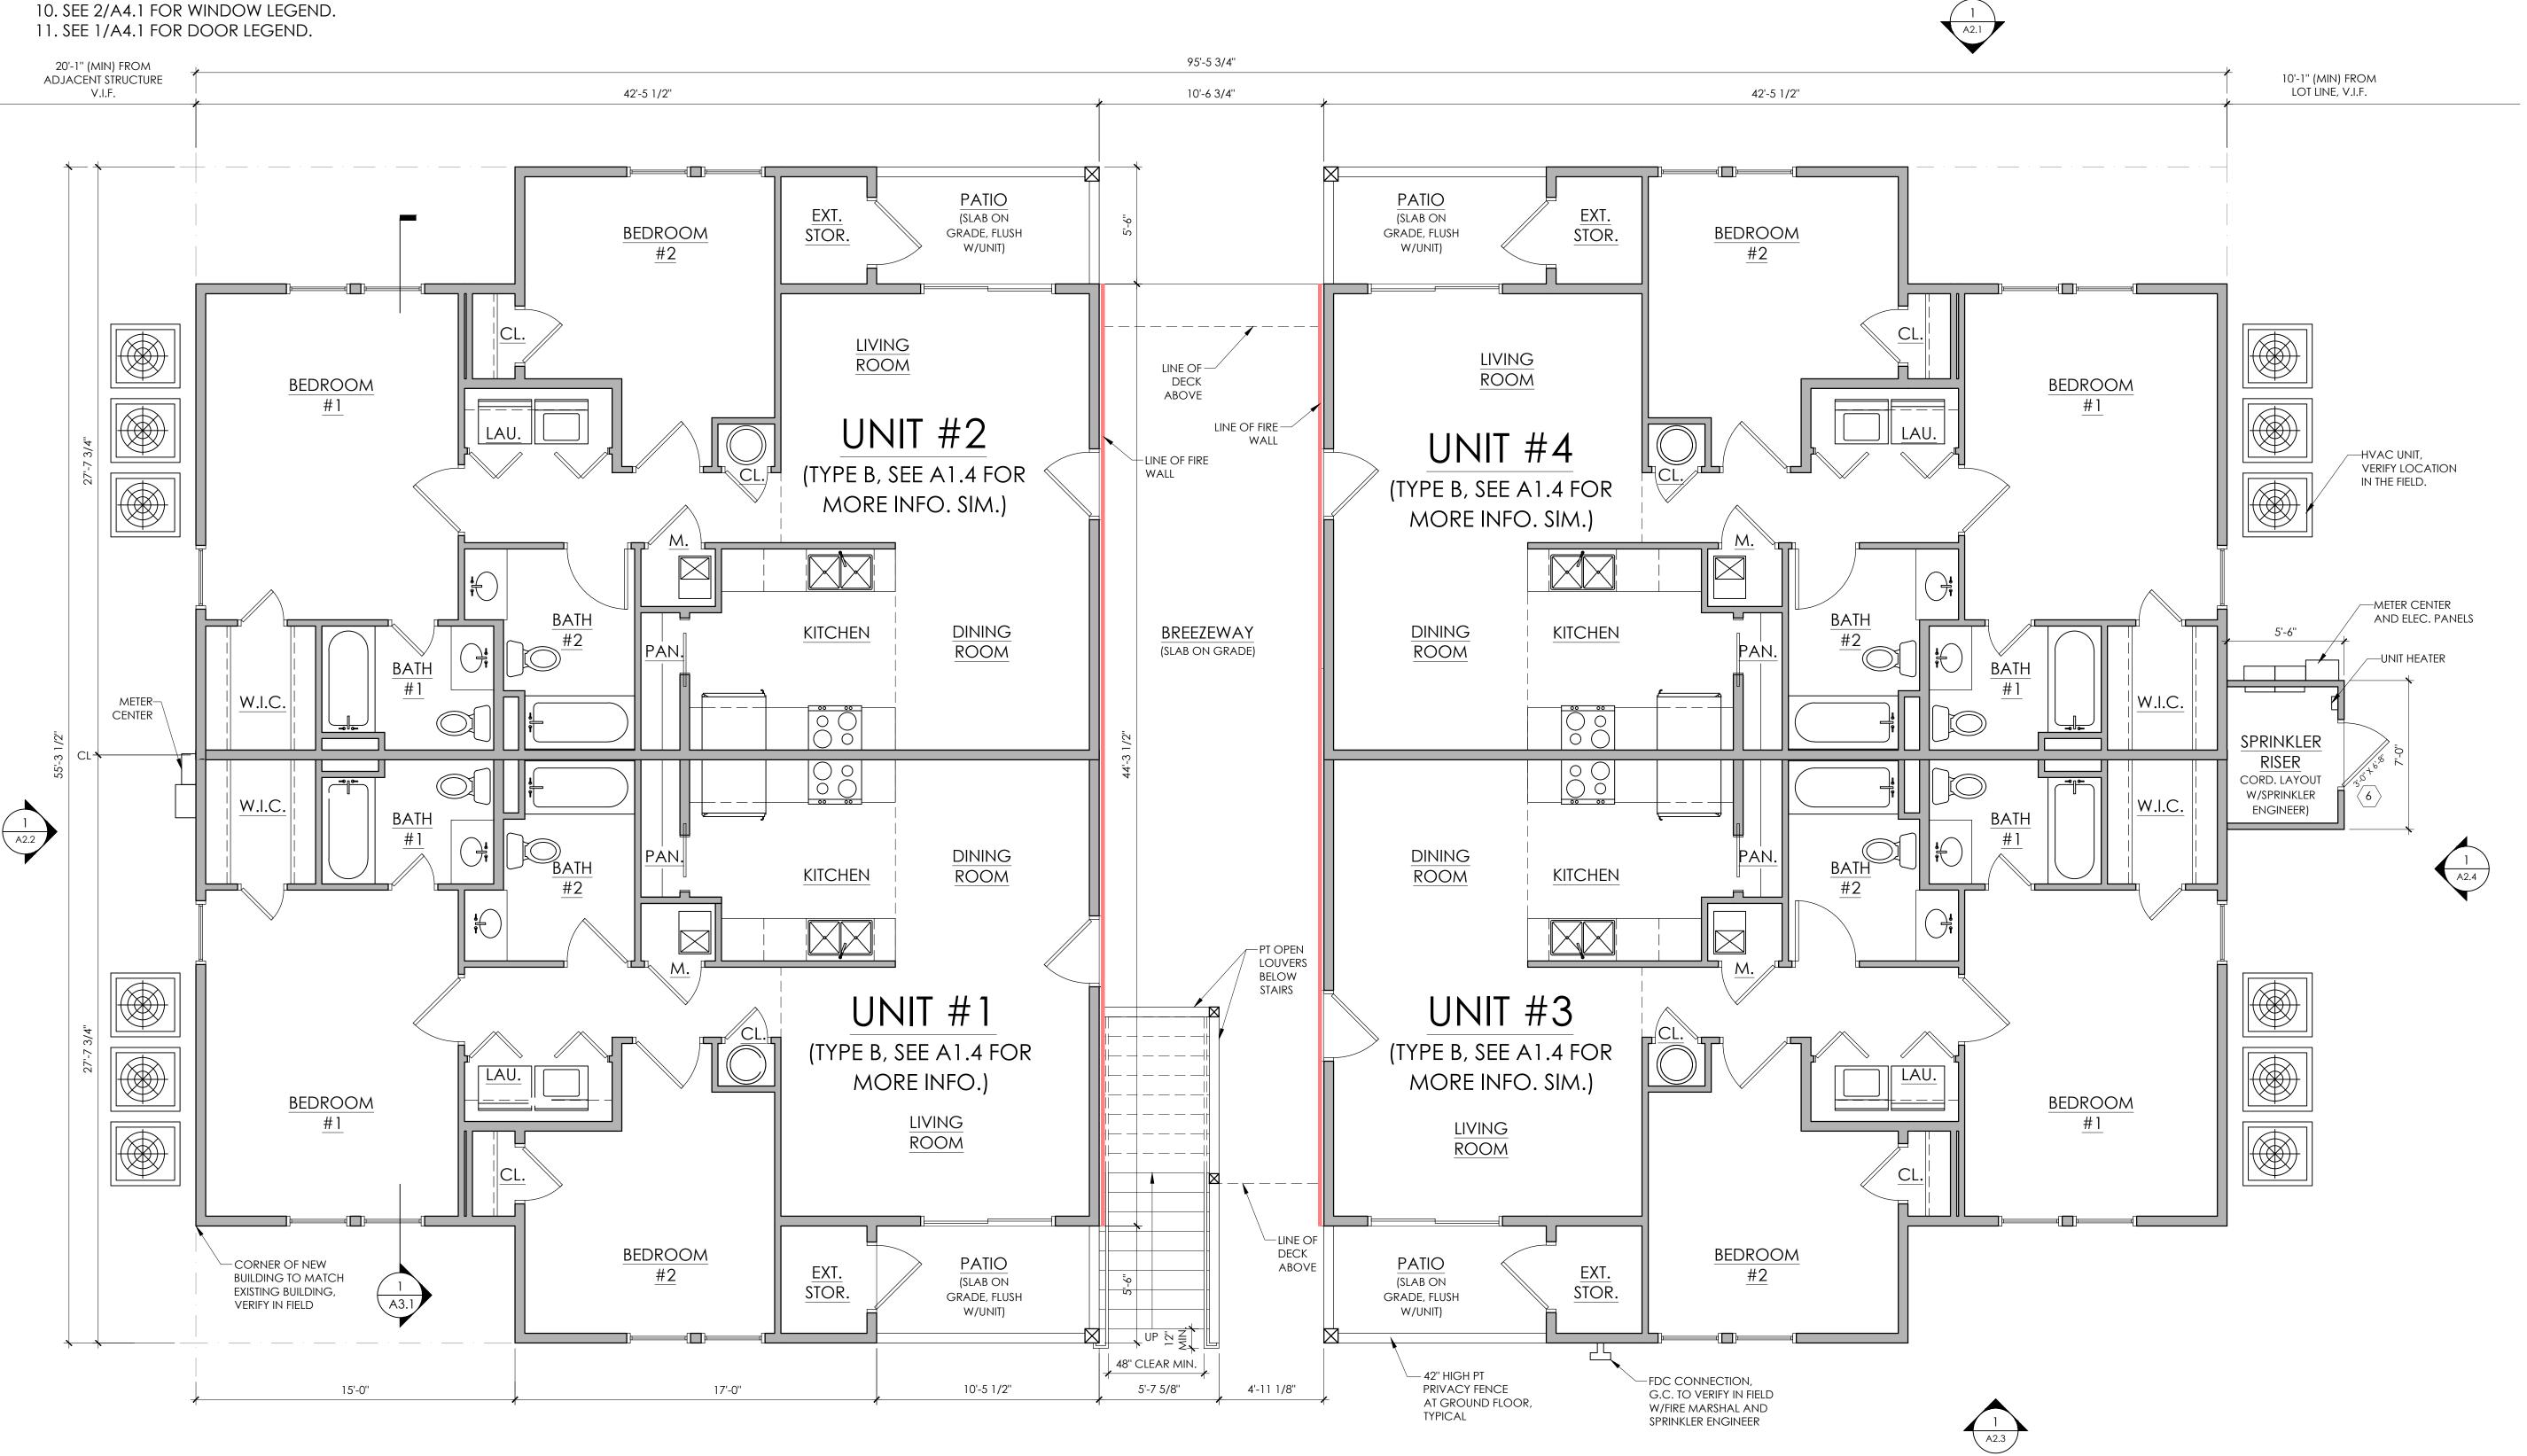
SHEET:

STAMP:

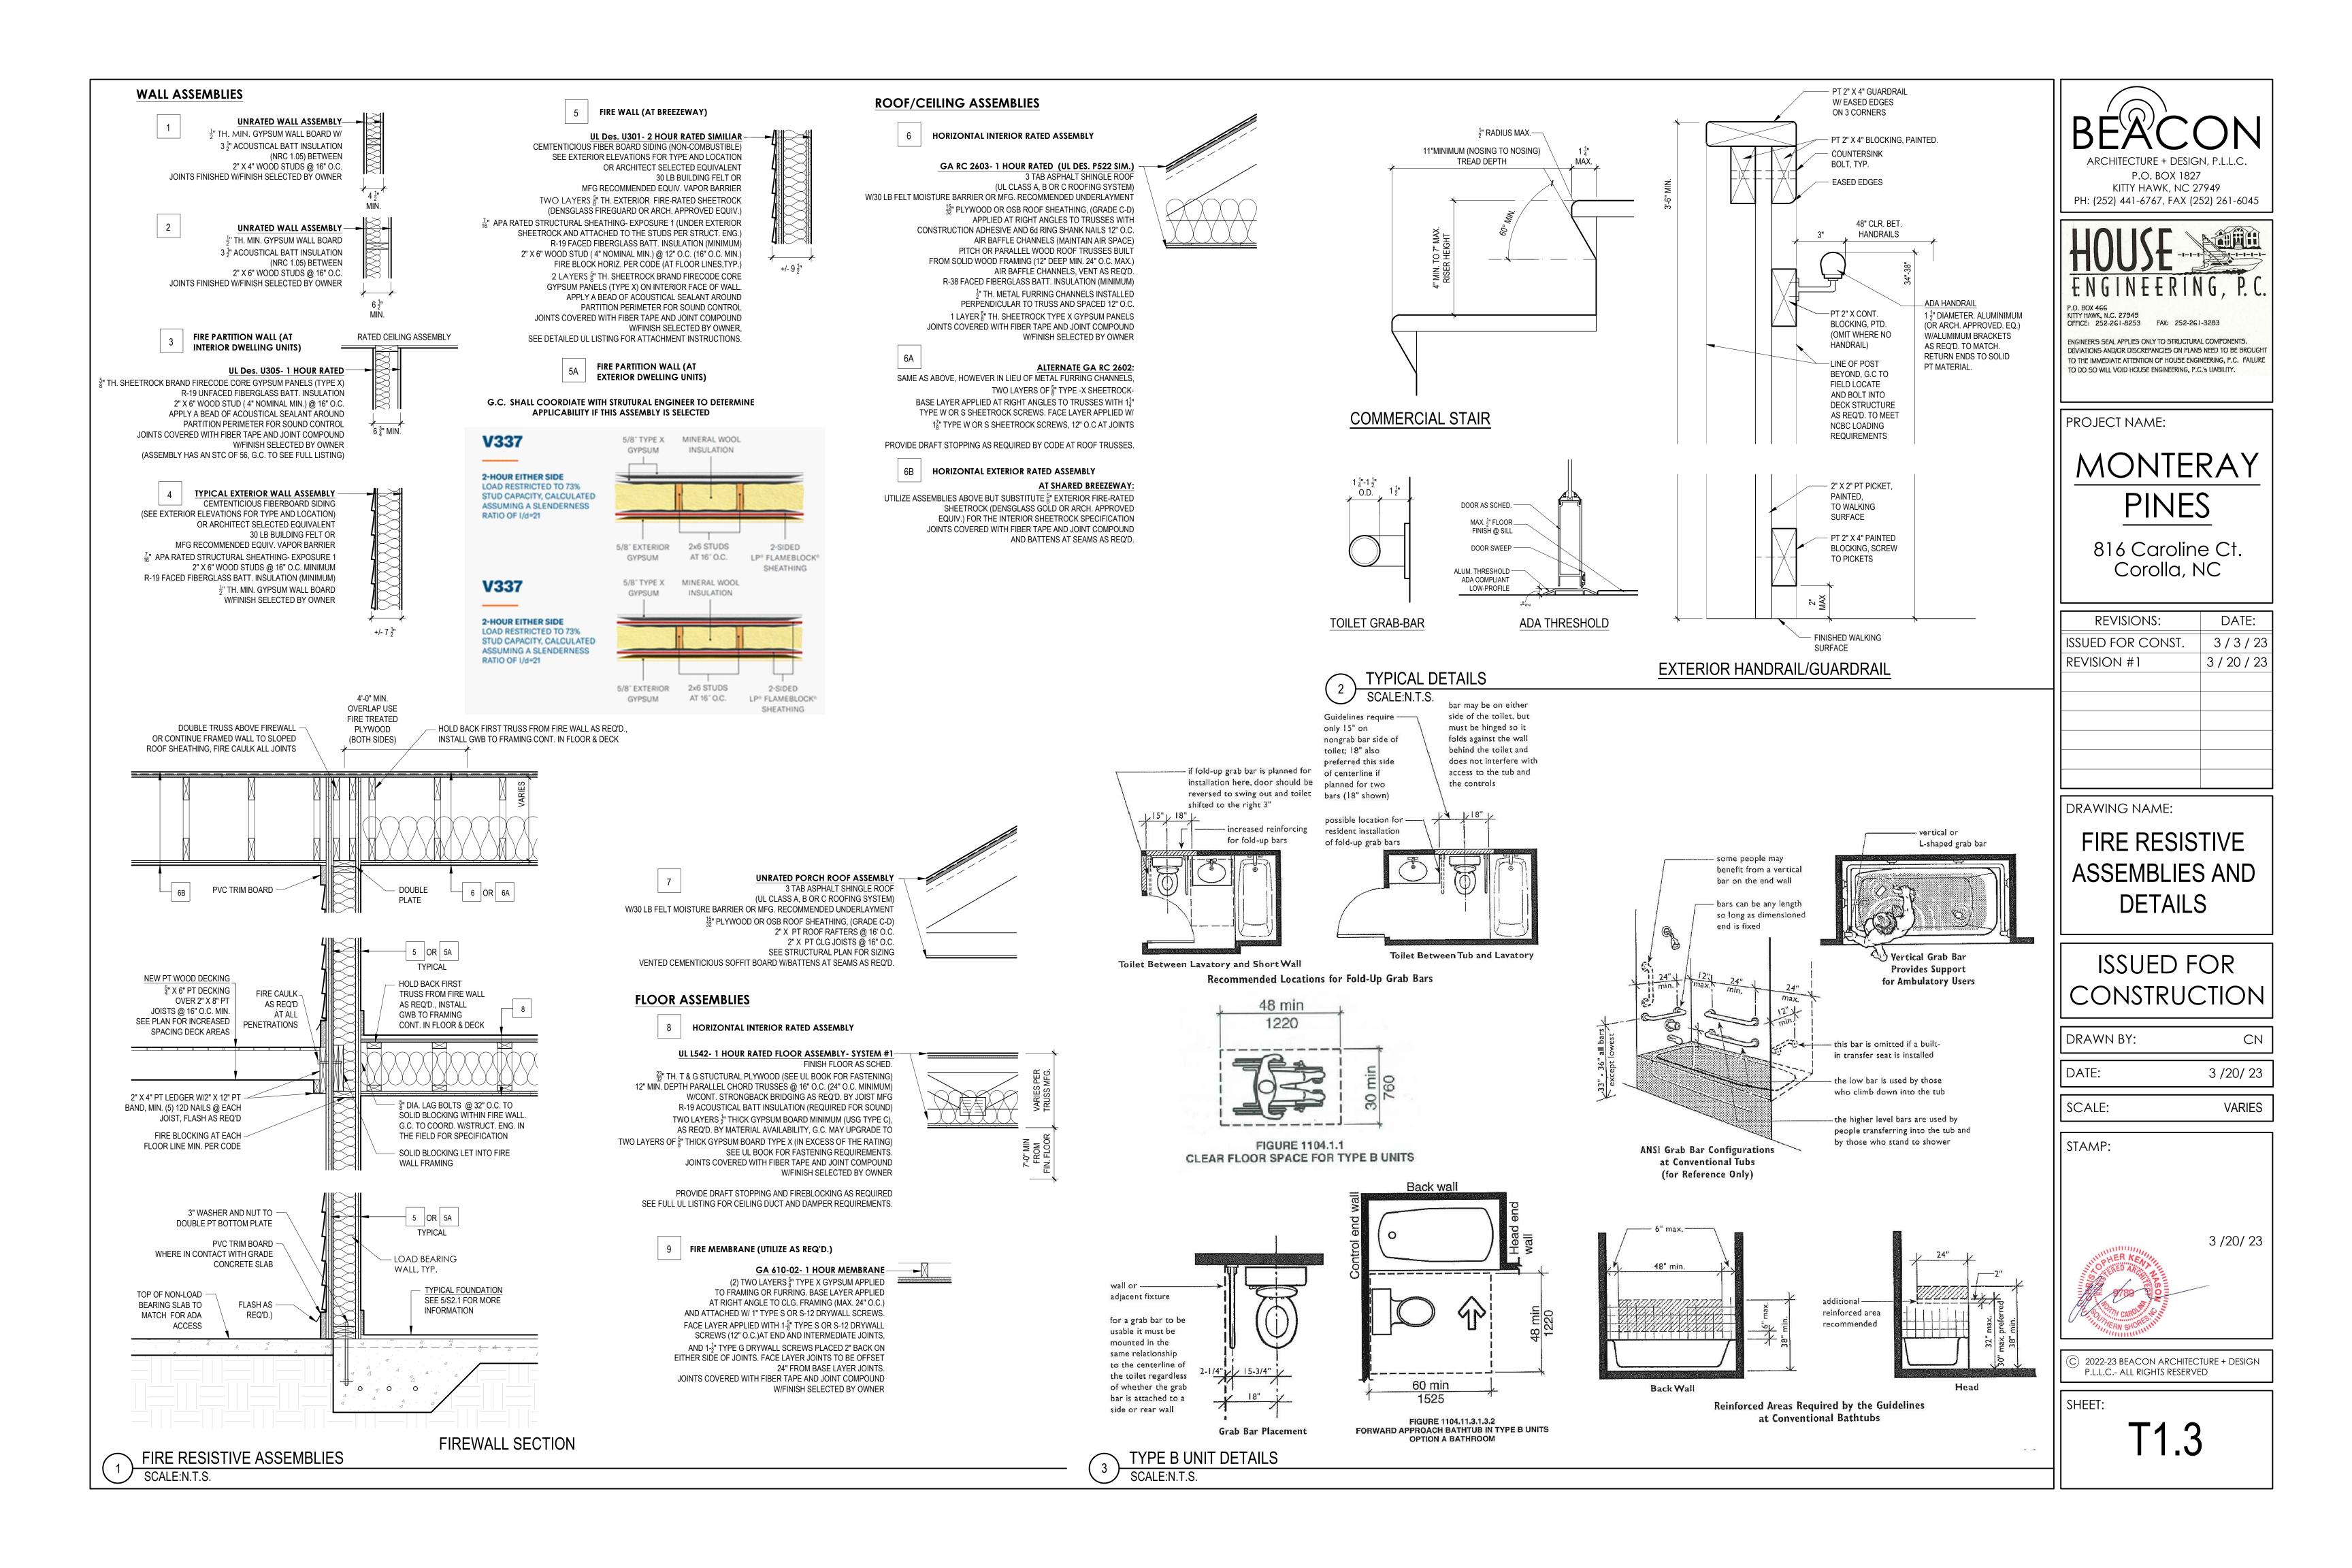

GENERAL NOTES:

- 1. INSPECT AND VERIFY ALL DIMENSIONS ON THE PROJECT AND SITE AS MAY RELATE TO THE EXTENT OF CONSTRUCTION AND/OR DEMOLITION.
- 2. THE CONTRACTOR/OWNER SHALL OBTAIN ALL REQUIRED PERMITS AND INSPECTIONS AS MAY BE REQUIRED TO PROCEED WITH DEMOLITION AND CONSTRUCTION.
- 3. ALL WORK PERFORMED SHALL MEET ALL TOWN, COUNTY AND STATE CODES.
- 4. DO NOT SCALE DRAWINGS.
- 5. VERIFY ALL DOOR/WINDOW ROUGH OPENINGS WITH DOOR MFG. SPEC.
- 6. ALL PILINGS SHALL BE AS DEEP AS REQUIRED TO MEET CODES. CONTRACTOR TO VERIFY IN THE FIELD
- 7. CONTRACTOR TO USE TEMPERED GLASS IN ANY WINDOW OR DOOR THAT IS WITHIN 18" OF THE FINISHED FLOOR.
- 8. CONTRACTOR TO CONFIRM PLAN DIMENSIONS PRIOR TO CONSTRUCTION WITH EXISTING SITE CONSTRAINTS. CONTRACTOR IS RESPONSIBLE FOR INFORMING THE ARCHITECT OF ANY PROBLEMS PRIOR TO CONSTRUCTION.
- 9. THE CONTRACTOR SHALL PROVIDE THE OWNER WITH ALL MANUALS AND MAINTENANCE INFORMATION BEFORE THE FINAL PAYMENT. THE CONTRACTOR SHALL WARRANTY THE WORK FOR THE PERIOD OF ONE YEAR.





P.O. BOX 466 KITTY HAWK, N.C. 27949 OFFICE: 252-261-8253 ENGINEER'S SEAL APPLIES ONLY TO STRUCTURAL COMPONENTS. DEVIATIONS AND/OR DISCREPANCIES ON PLANS NEED TO BE BROUGH

TO THE IMMEDIATE ATTENTION OF HOUSE ENGINEERING, P.C. FAILUR

TO DO SO WILL VOID HOUSE ENGINEERING, P.C.'S LIABILITY.

PROJECT NAME:

MONTERAY PINES

816 Caroline Ct. Corolla, NC

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REVISION #1	3 / 20 / 23

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BUILDING PLANS

ISSUED FOR CONSTRUCTION

DRAWN BY: CN 3 /20/ 23 DATE: SCALE:

STAMP:


3 /20/ 23

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SHEET:

A1.1

GROUND FLOOR PLAN SCALE: $\frac{1}{4}$ " = 1'-0"

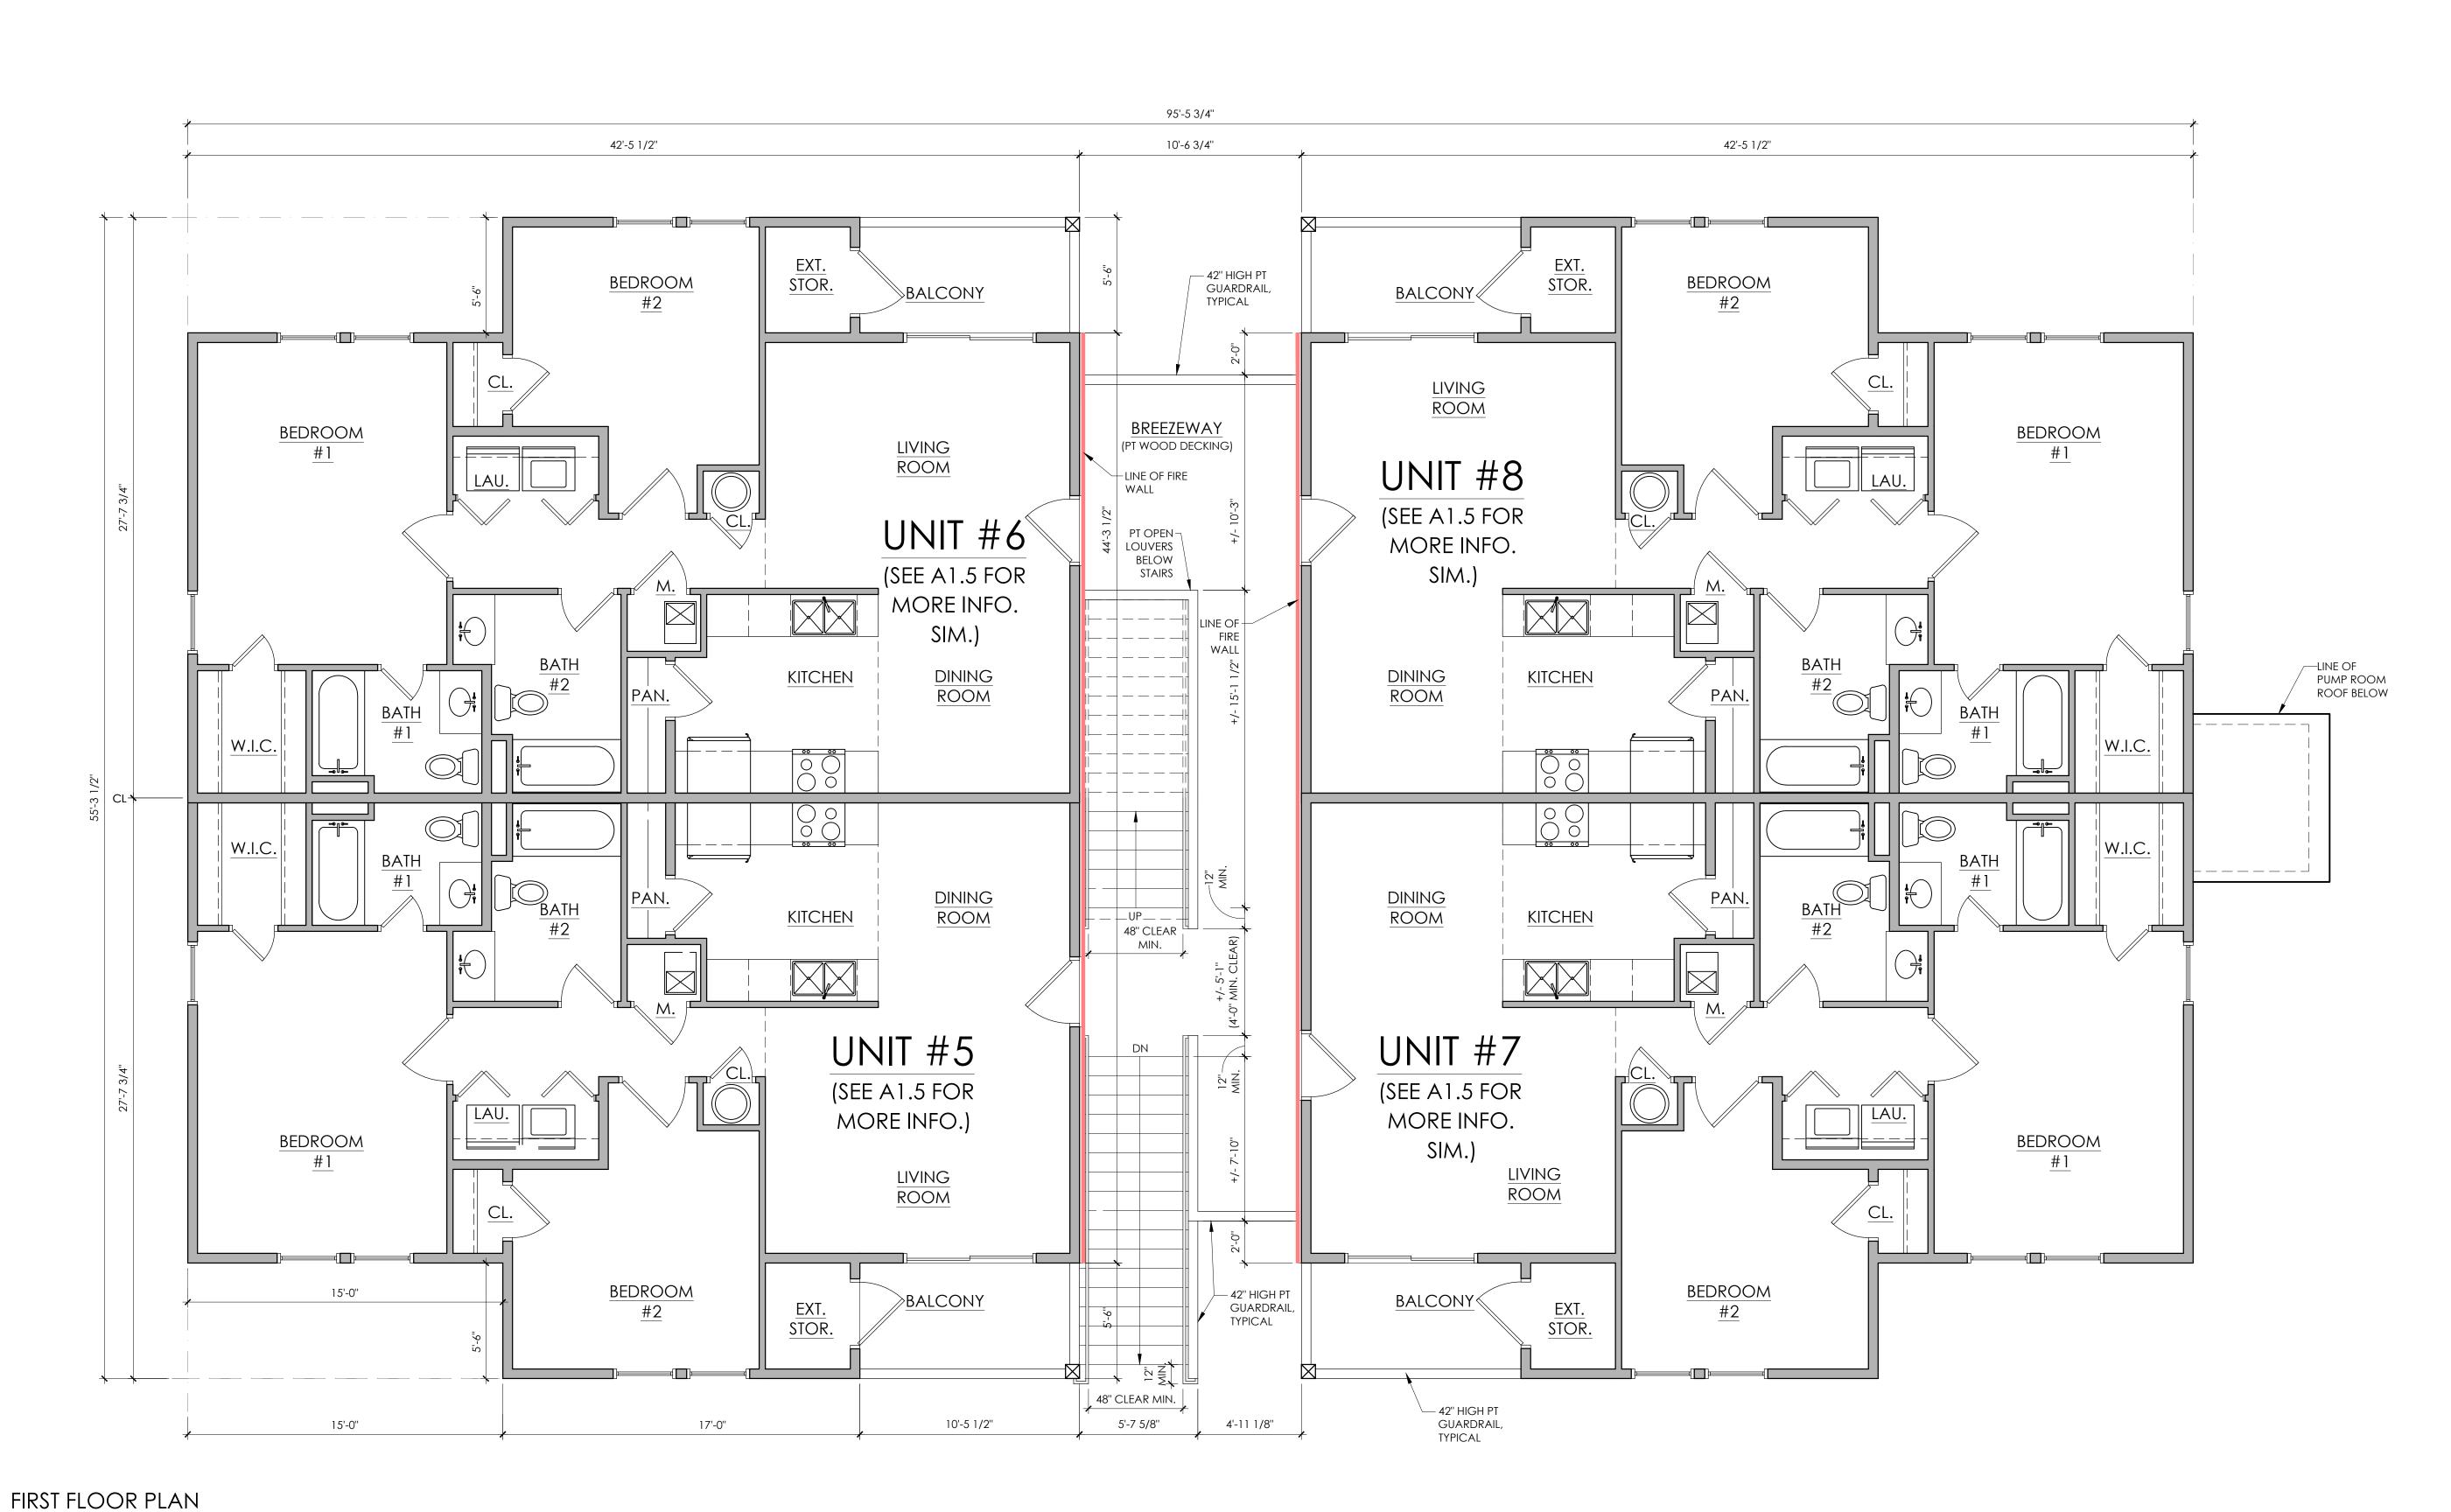

1 SCALE: $\frac{1}{4}$ " = 1'-0"



CE: 252-261-8253 FAX: 252-261-3283

ENGINEER'S SEAL APPLIES ONLY TO STRUCTURAL COMPONENTS.
DEVIATIONS AND/OR DISCREPANCIES ON PLANS NEED TO BE BROUGHT
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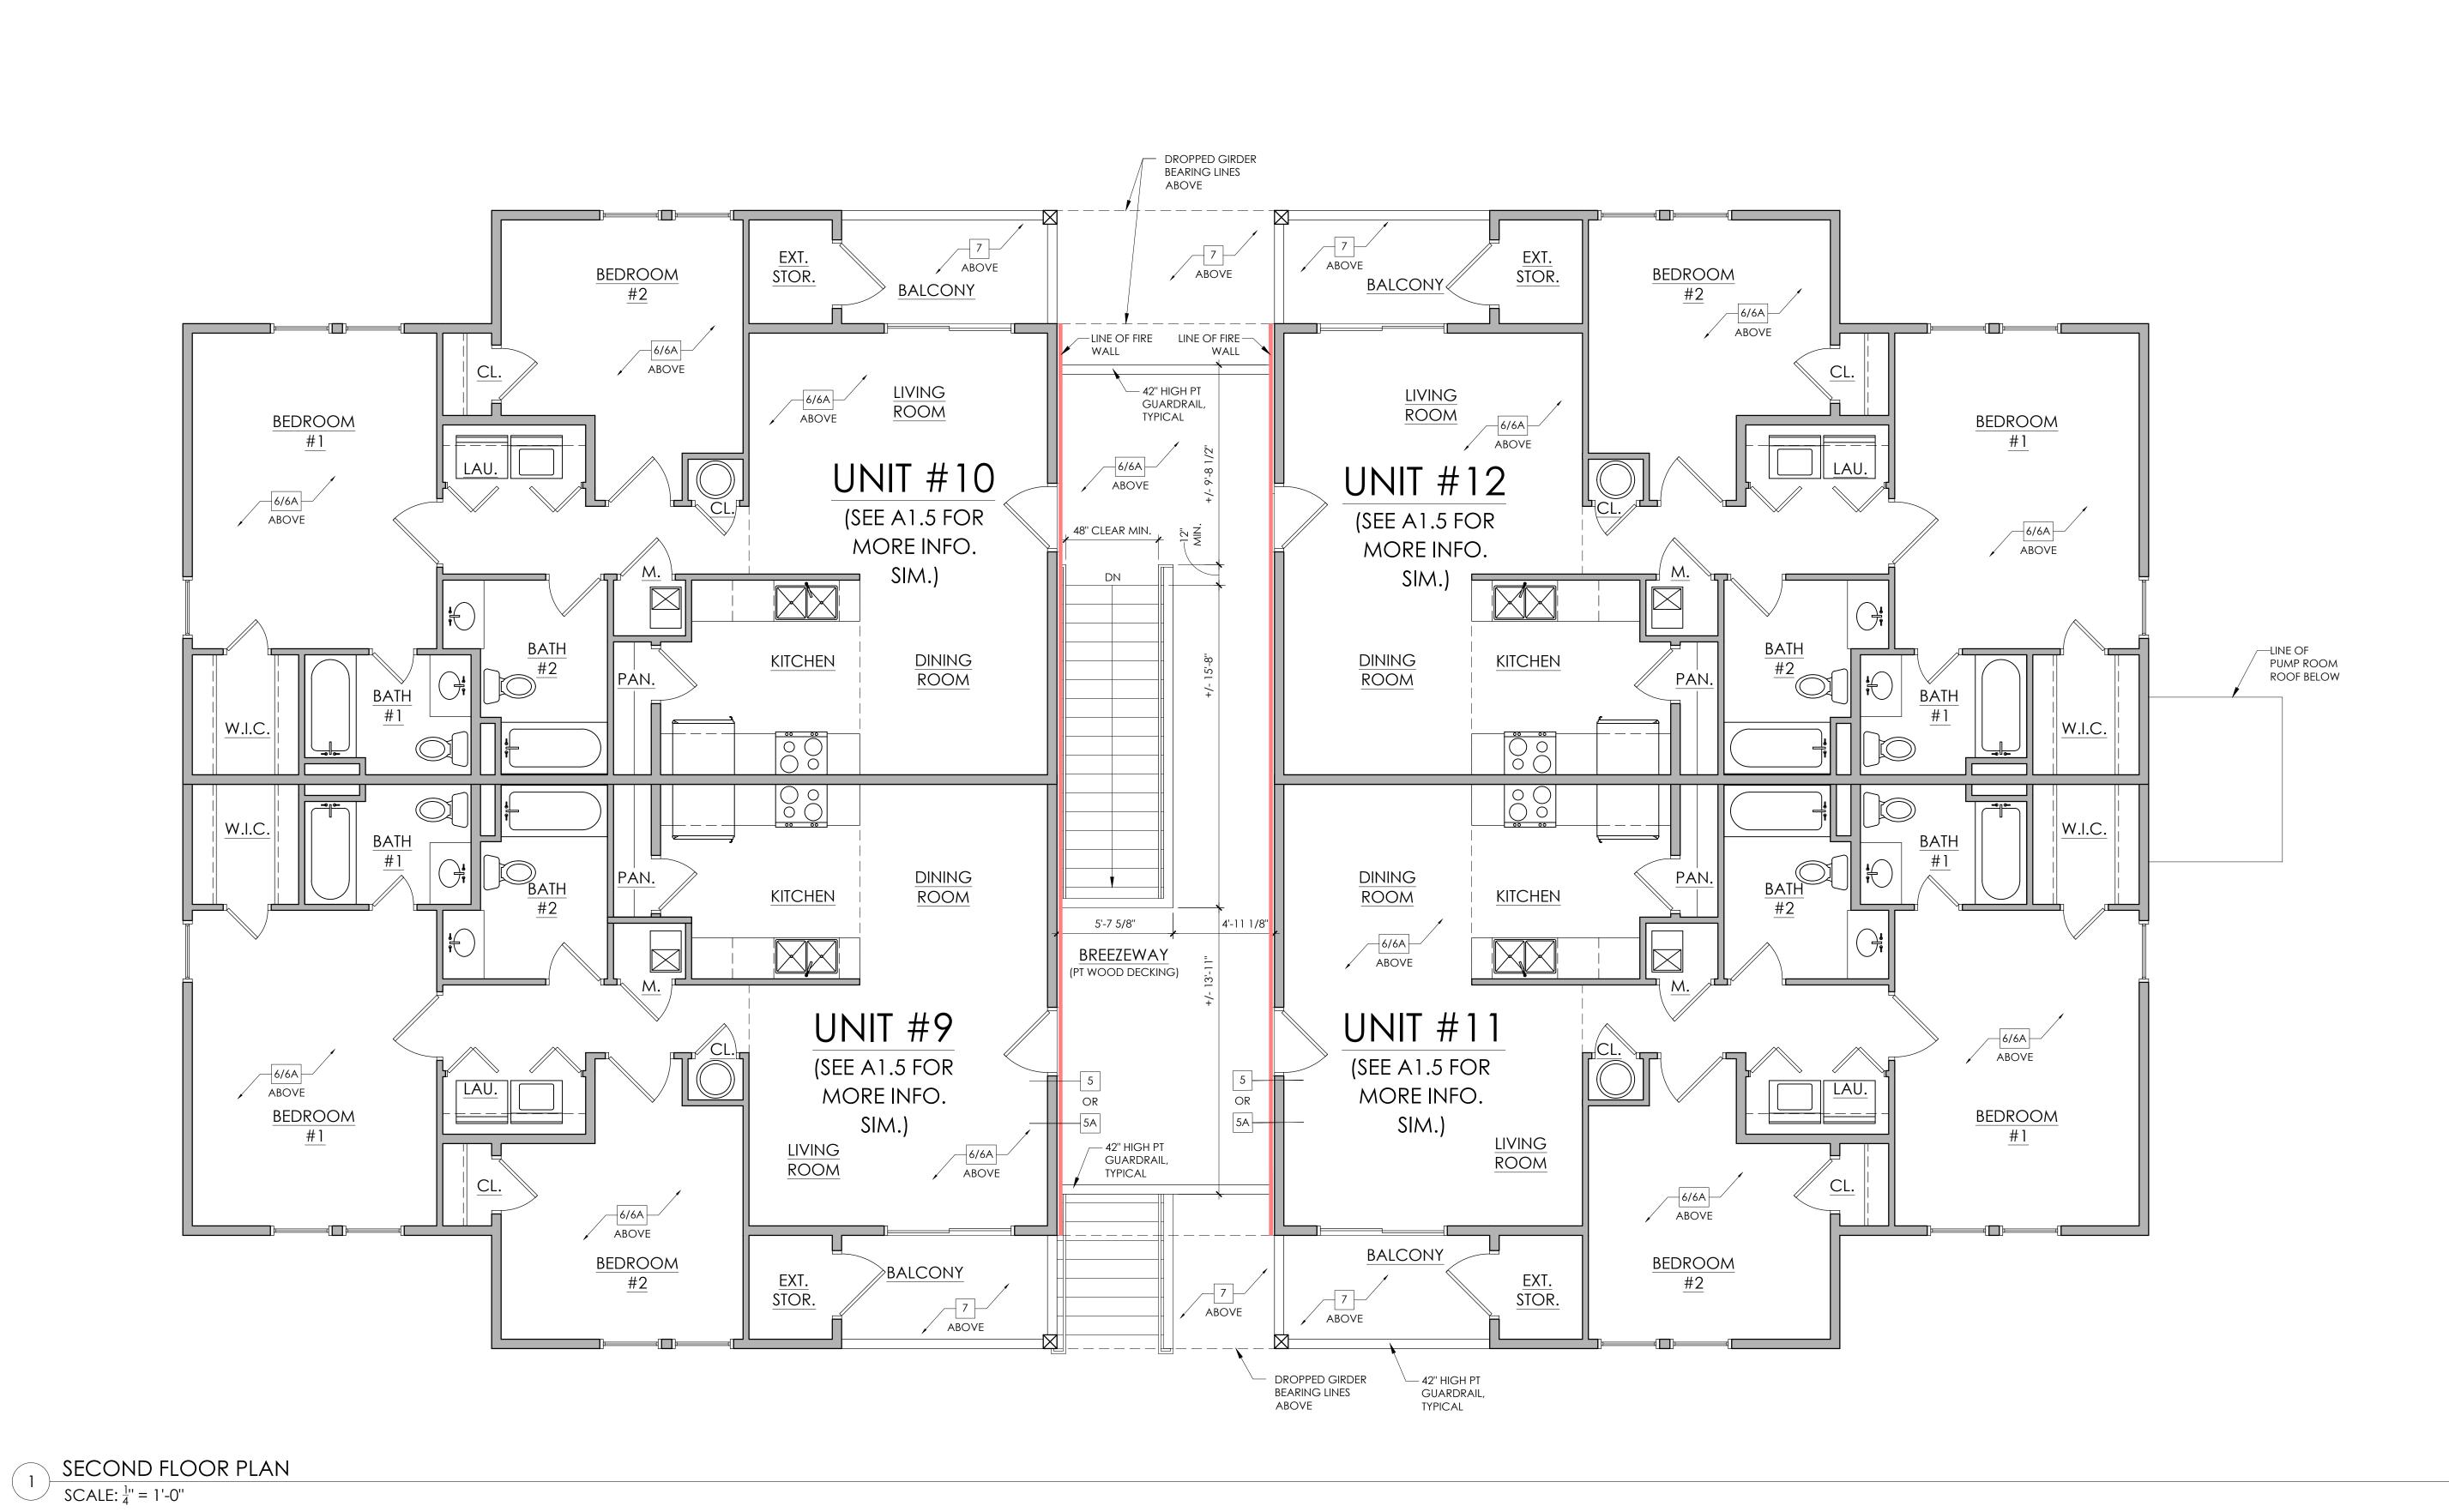
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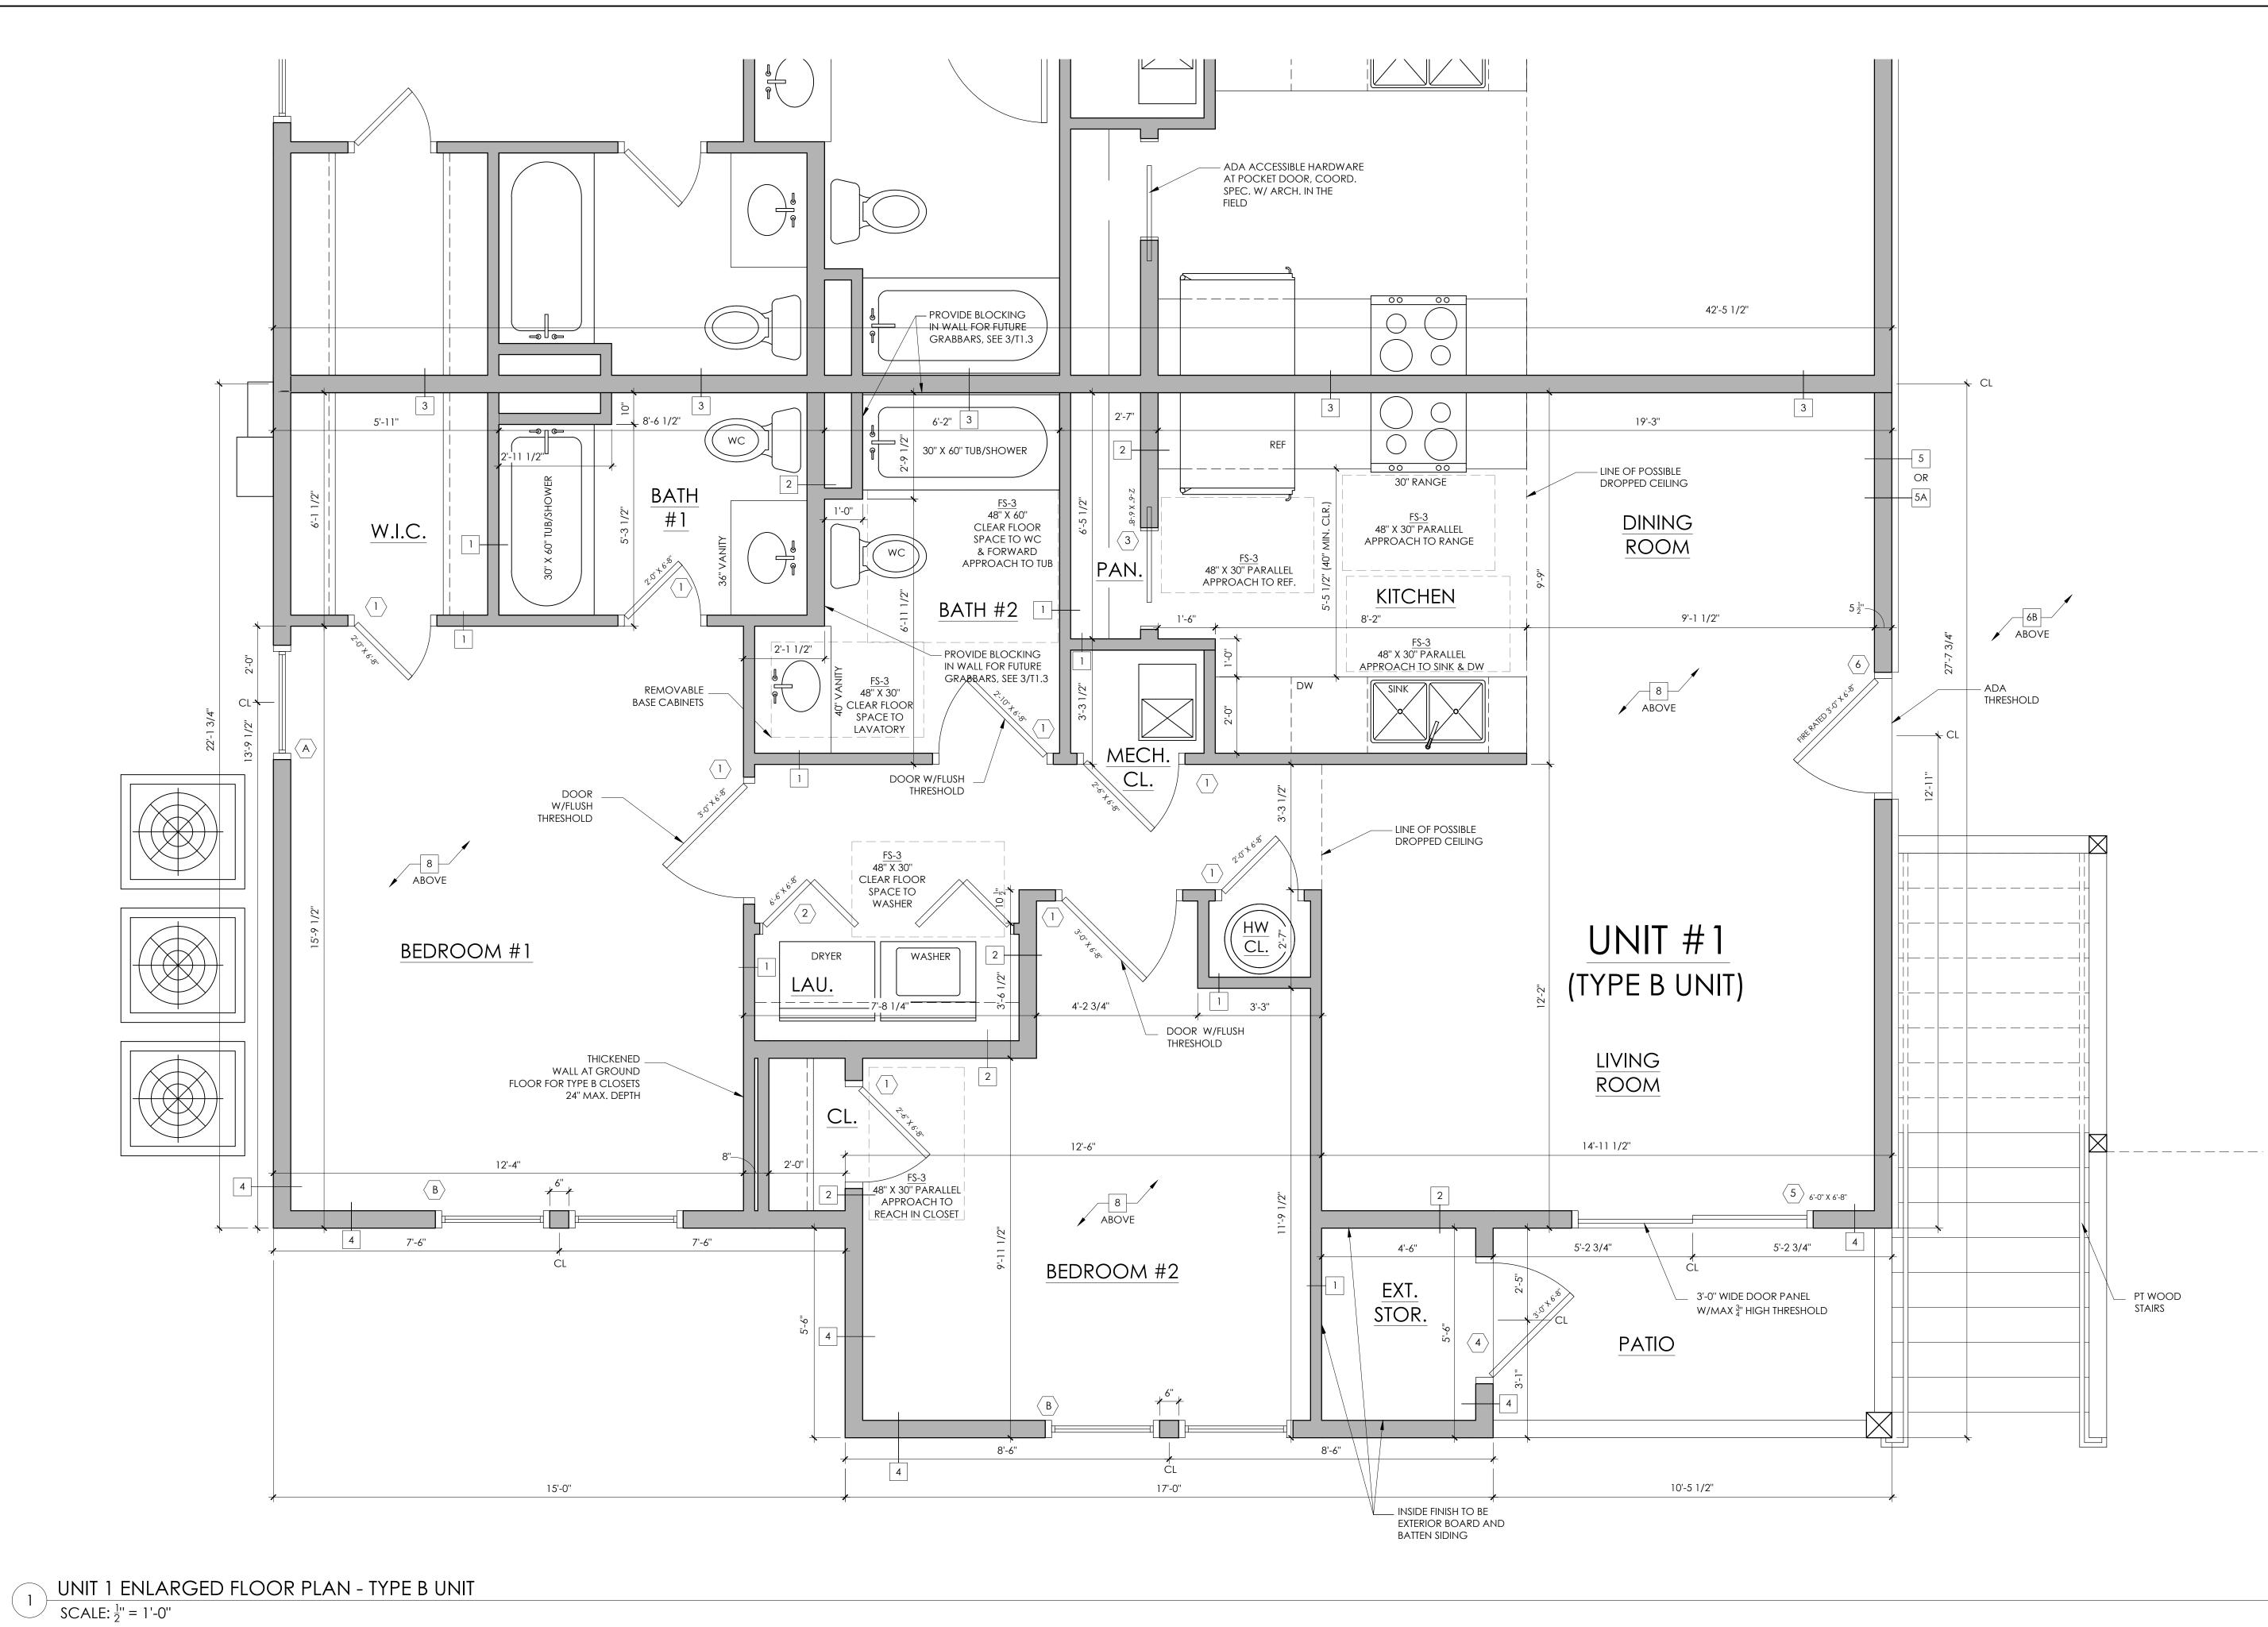
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BEACON

ARCHITECTURE + DESIGN, P.L.L.C.

P.O. BOX 1827

KITTY HAWK, NC 27949

PH: (252) 441-6767, FAX (252) 261-6045

HOUSE ERING, P. C.

P.O. BOX 466 KITTY HAWK, N.C. 27949 OFFICE: 252-261-8253 FAX: 252-261-3283

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DRAWING NAME:

ENLARGED UNIT PLAN

ISSUED FOR CONSTRUCTION

 DRAWN BY:
 CN

 DATE:
 3 /20/ 23


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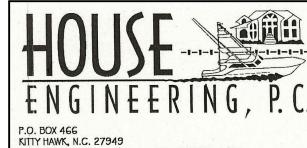
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revisions:	DATE:
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REVISION #1	3 / 20 / 23

CN 3 /20/ 23





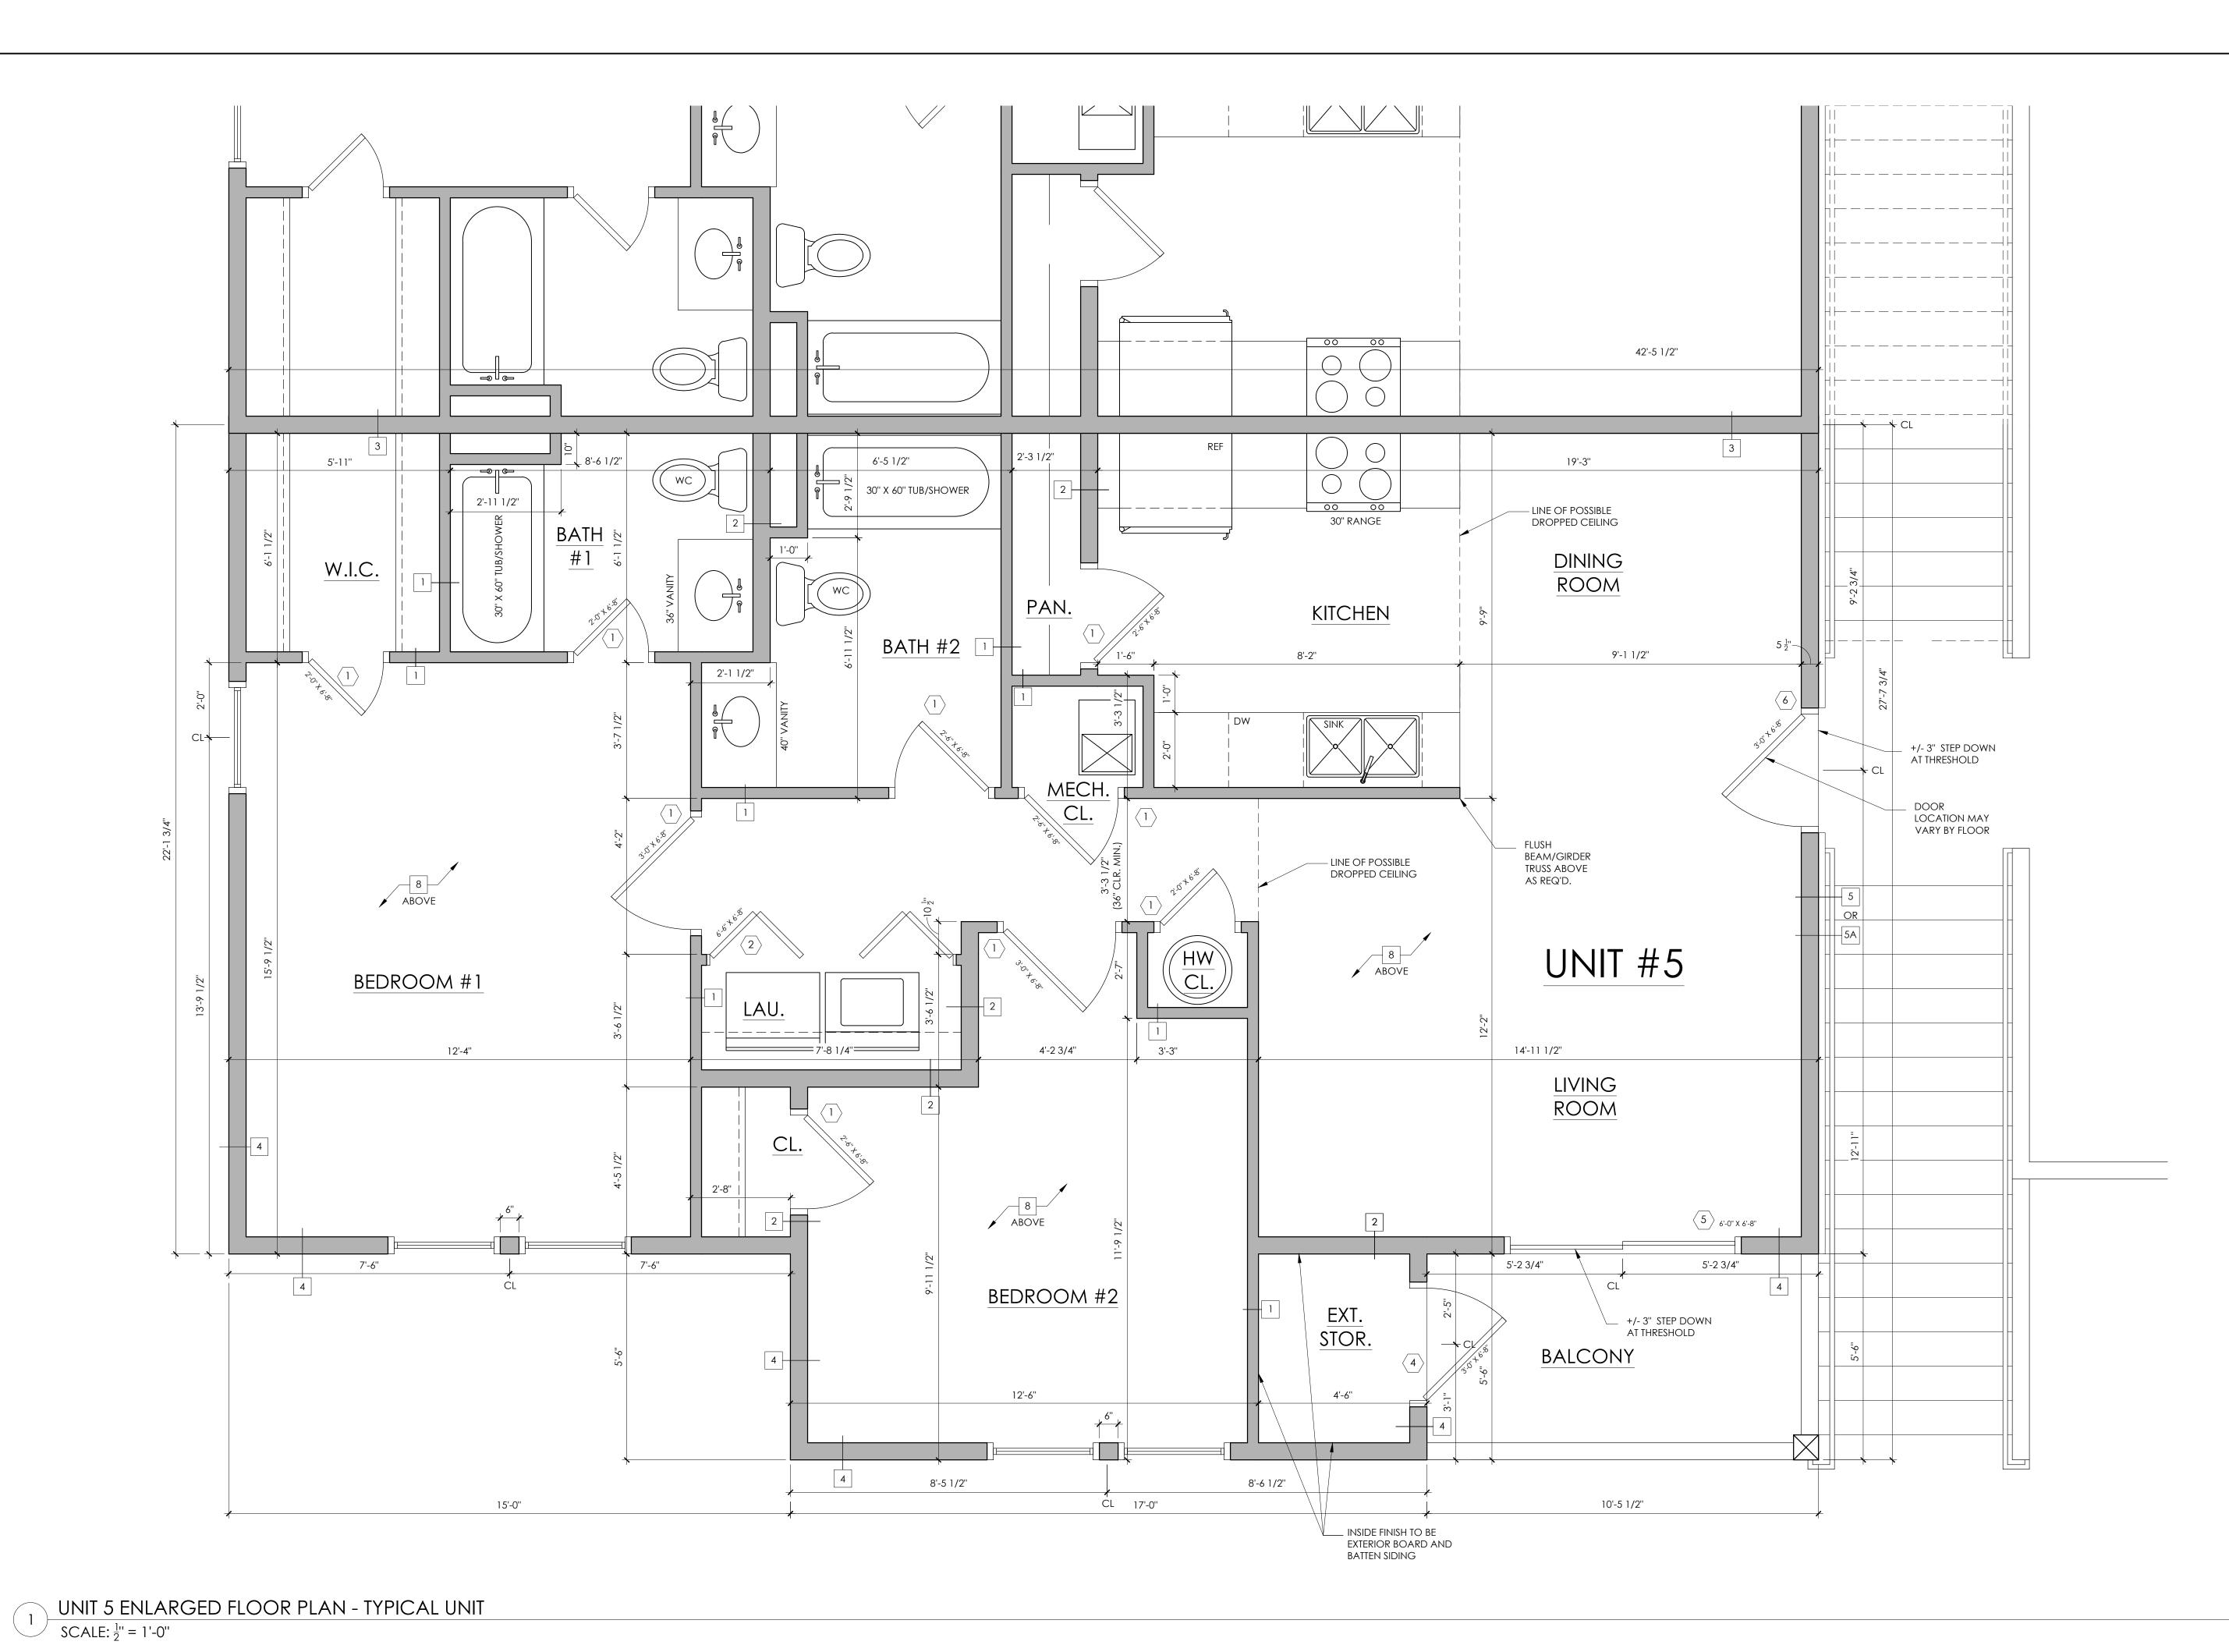

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ENGINEER'S SEAL APPLIES ONLY TO STRUCTURAL COMPONENTS. DEVIATIONS AND/OR DISCREPANCIES ON PLANS NEED TO BE BROUGHT TO THE IMMEDIATE ATTENTION OF HOUSE ENGINEERING, P.C. FAILURE TO DO SO WILL VOID HOUSE ENGINEERING, P.C.'S LIABILITY.

PROJECT NAME:

MONTERAY PINES

816 Caroline Ct. Corolla, NC

REVISIONS:	DATE:
ISSUED FOR CONST.	3/3/23
REVISION #1	3 / 20 / 23

DRAWING NAME:

EXTERIOR ELEVATION

ISSUED FOR CONSTRUCTION

DRAWN BY: CN 3 /20/ 23 DATE:

STAMP:

SCALE:

3 /20/ 23

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A2.2





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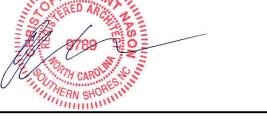
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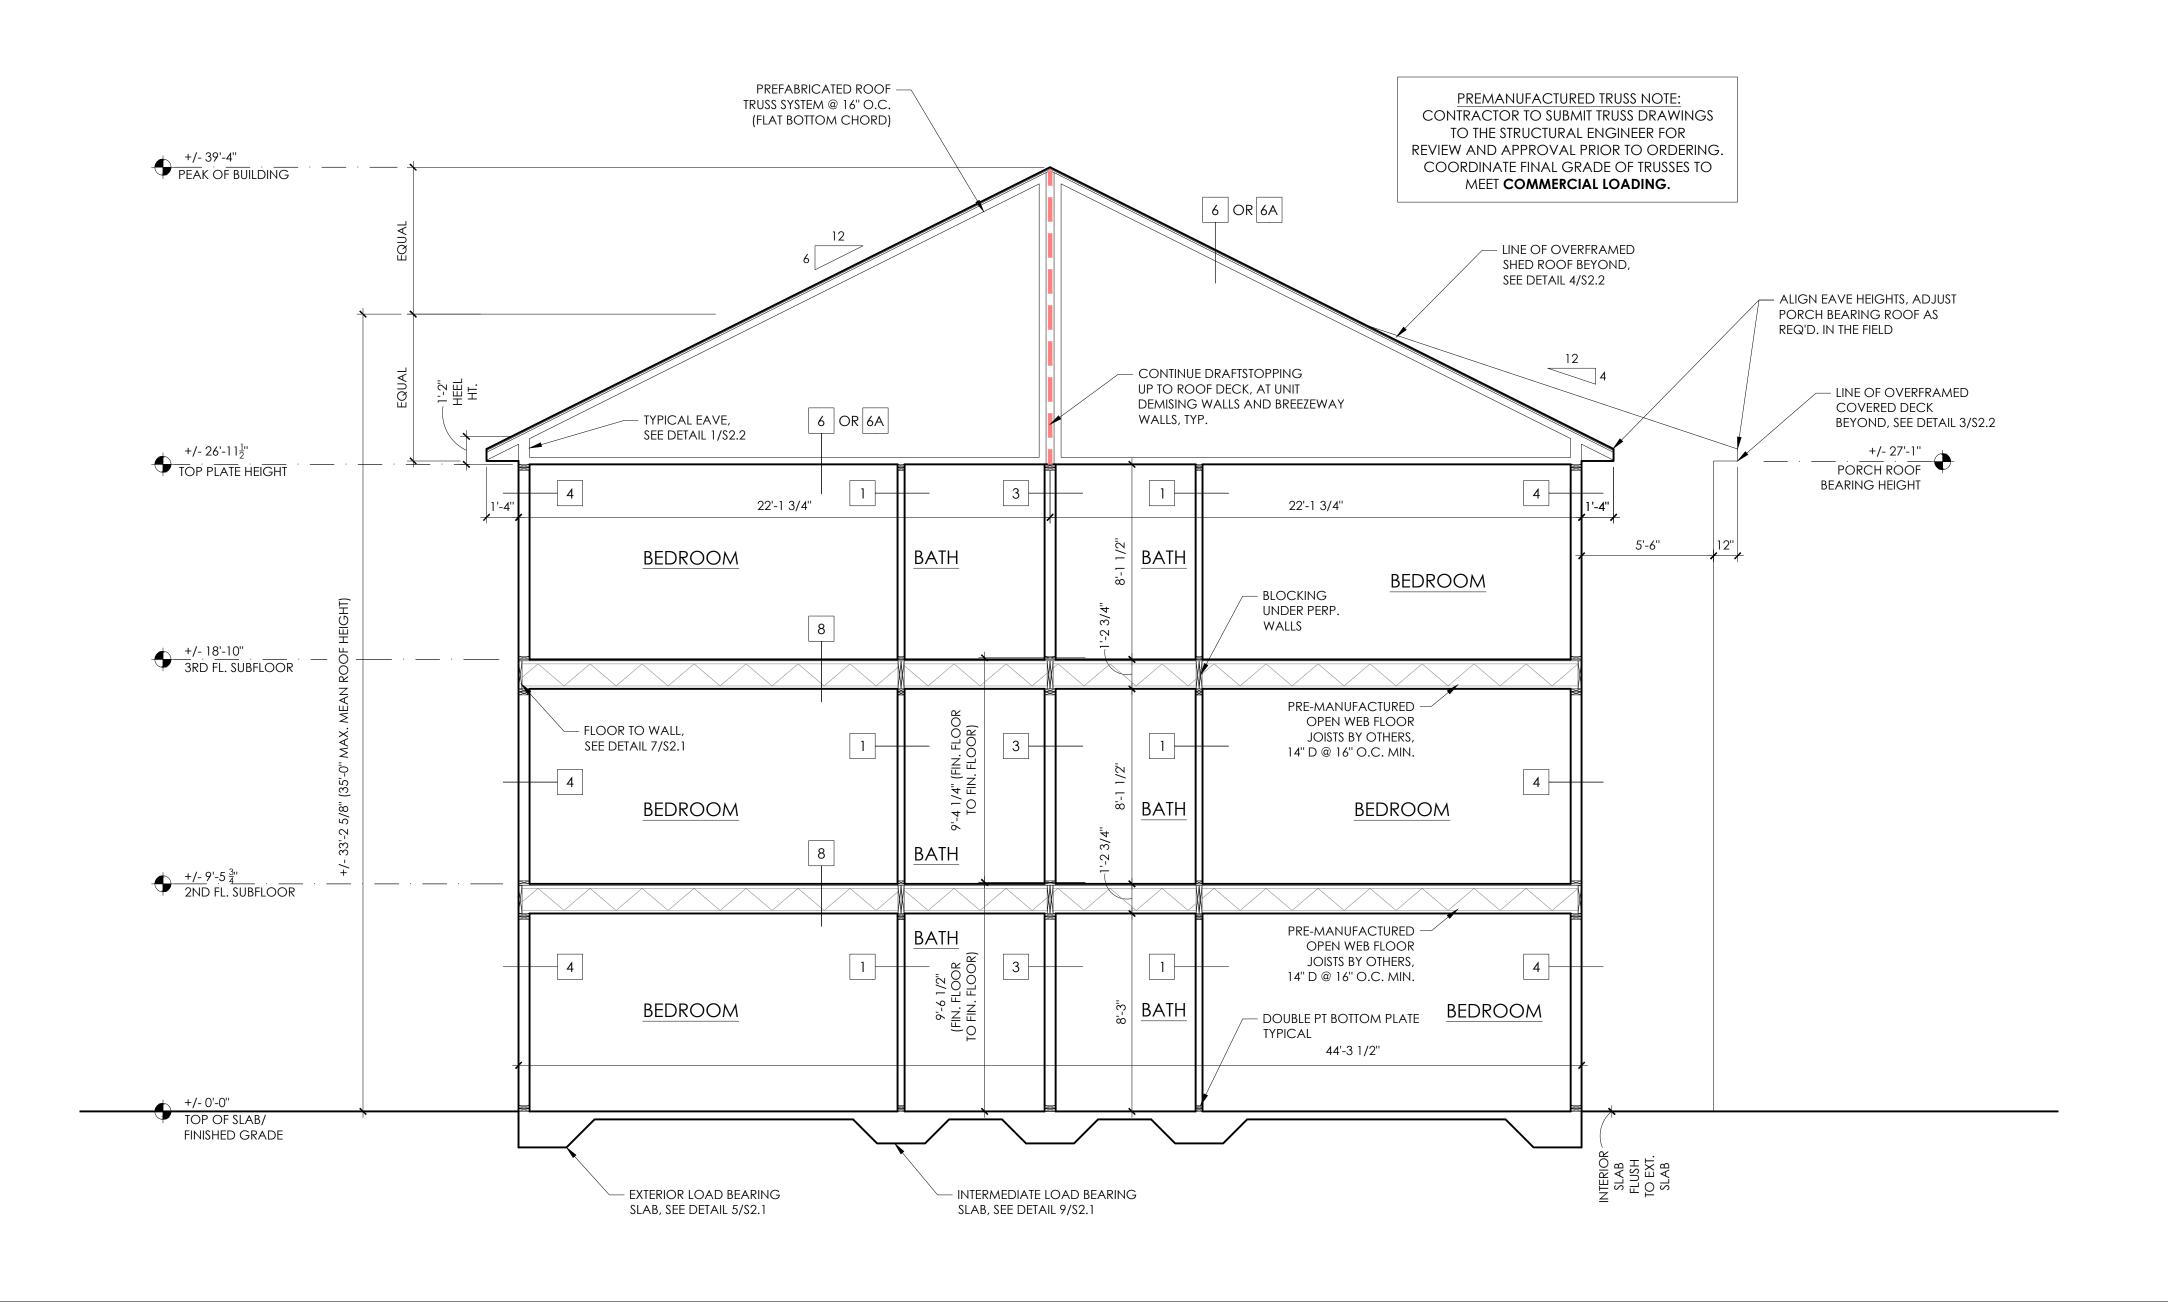


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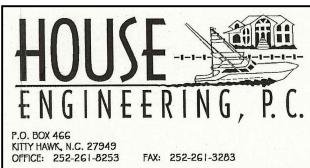
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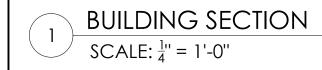
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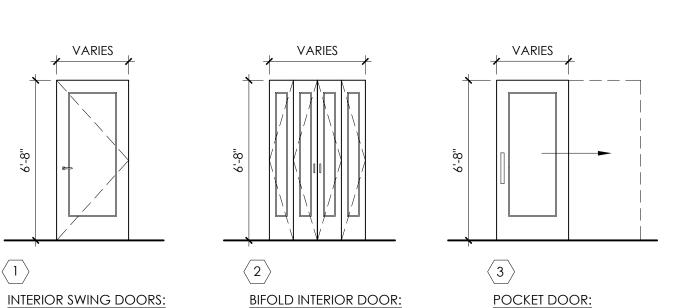
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A3.1





SOLID-CORE WOOD,

PAINT GRADE, SINGLE PANEL

6'-6" R.O.

SET OF DOUBLE HUNG

(EGRESS)

WINDOWS, FIELD MULLED

SOLID-CORE WOOD

PAINT GRADE, SINGLE PANEL

DOOR LEGEND

NOT TO SCALE

DOUBLE HUNG

WINDOW LEGEND

WINDOW

(EGRESS)

2 WINDOW LE NOT TO SCALE

SOLID-CORE WOOD,


W/ADA ACCESSIBLE

HARDWARE

PAINT GRADE, SINGLE PANEL

WINDOW NOTES:

PROJECT LOCATION

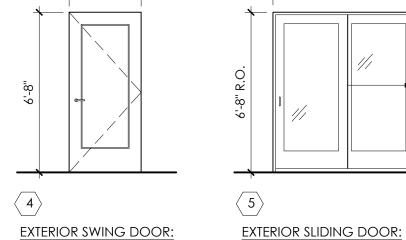


INSULATED FIBERGLASS

DOOR, SINGLE PANEL,

PAINT GRADE

1. MUNTINS ARE TO BE AS SHOWN ON WINDOW TYPES.

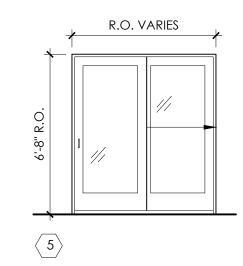

FIBERGLASS DOOR WITH

FULL-LITE GLASS PANELS,

3. ALL WINDOW SIZES ARE APPROXIMATE AND DO NOT REPRESENT ROUGH OPENING SIZES. ACTUAL SIZE MAY VARY DEPENDING UPON FINAL MFG.

WINDOW MANUF. OR OTHERS. WINDOW CONFIGURATIONS TO BE VERIFIED FOR INTENDED USE IN HIGH WIND ZONES. WINDOW UNITS IN MULTIPLE

4. ALL WINDOWS TO BE DESIGNED FOR 130 MPH WIND VELOCITY (3 SEC. GUST). WINDOW ATTACHMENT TO WALL STUDS TO BE DESIGNED BY

5. G.C. TO CONFIRM IF WINDOWS AND DOORS TO MEET ASTM-E 1996 AND ASTM-E 1886 STANDARDS FOR WIND BOURNE DEBRIS BASED UPON

8. G.C. TO PROVIDE WINDOW SUBMITTALS TO ARCHITECT FOR REVIEW DURING CONSTRUCTION AND PRIOR TO PURCHASE.


PAINT GRADE

2. SET ALL WINDOWS AT 6'-8" A.F.F. TO MATCH DOORS U.O.N. SEE EXTERIOR ELEVATIONS FOR MORE INFO.

CONFIGURATIONS TO BE SELF SUPPORTING, MULLIONS TO BE DESIGNED BY MANUFACTURER OR OTHERS.

6. WINDOW COLOR TO BE WHITE, UNLESS OTHERWISE REQUESTED BY THE ARCHITECT.

7. WINDOWS SHOULD MEET 2018 NC ENERGY CODE REQUIREMENTS (U-VALUES AND SHGC).

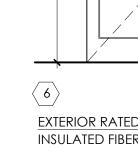


EXTERIOR RATED SWING DOOR: INSULATED FIBERGLASS DOOR, 20-MIN RATED DOOR AND FRAME, SINGLE PANEL, PAINT GRADE

NOTES:

1. FOR INTERIOR DOORS, WIDTH AND HEIGHT VALUES REPRESENT ACTUAL DOOR SIZE AND NOT FRAME SIZE.

2. ALL FRAMES THAT ARE PART OF A RATED ASSEMBLY MUST BE RATED.

- 3. CONTRACTOR TO CONFIRM THE CORRECT "HAND" OF EACH DOOR PRIOR TO PURCHASING 4. ALL LOCKSETS AND LATCHSETS TO RECEIVE ADA APPROVED LEVER HANDLES.
- 5. ALL RATED DOORS TO HAVE CLOSERS.

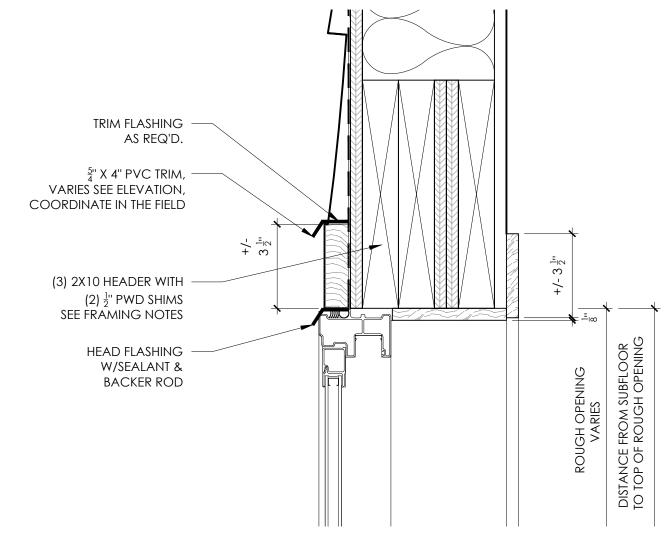

WINDOW AS — SCHEDULED AS REQ'D.

REVISION #1 3 / 20 / 23 DRAWING NAME:

ARCHITECTURE + DESIGN, P.L.L.C.

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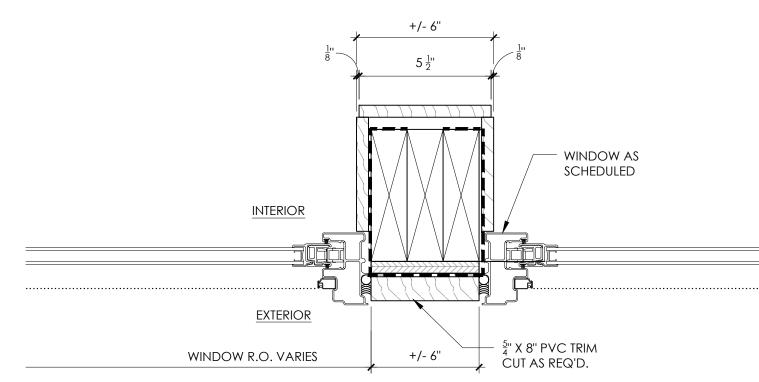
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HEAD SILL FLASHING - $\frac{5}{4}$ " X 4" PVC TRIM, VARIES SEE ELEVATION, COORDINATE IN THE FIELD

5" X 4" PVC TRIM

JAMB

SILL



JOINING MULLION

6" MINIMUM DOOR AS SCHED.—

3 TYPICAL DOOR JAMB DETAIL NOT TO SCALE

DOOR CASING BY CONTRACTOR—

4 TYPICAL WINDOW DETAILS
NOT TO SCALE

SHEET:

