

CONSTRUCTION DOCUMENTS FOR CONSTRUCTION

# HISTORIC COROLLA PARK / WHALEHEAD

LANDSCAPE AND PEDESTRIAN IMPROVEMENTS - PHASE I



WHALEHEAD CLUB CLUB ROAD COROLLA, NC 27927

# **INDEX OF SHEETS**


- EXISTING CONDITIONS PLAN
- SITE CONTEXT/ SHEET EXTENTS PLAN
- DEMOLITION PLAN
- DEMOLITION PLAN
- LAYOUT & MATERIALS PLAN LAYOUT & MATERIALS PLAN
- GRADING PLAN
- GRADING PLAN
- PLANTING PLAN
- PLANTING PLAN
- DETAILS
- DETAILS
- DETAILS

# LIGHTING/ELECTRICAL

ELECTRICAL GENERAL NOTES, LEGEND, ABBREVIAT
ELECTRICAL SITE PLANS



ATIONS & SPECIFICATIONS

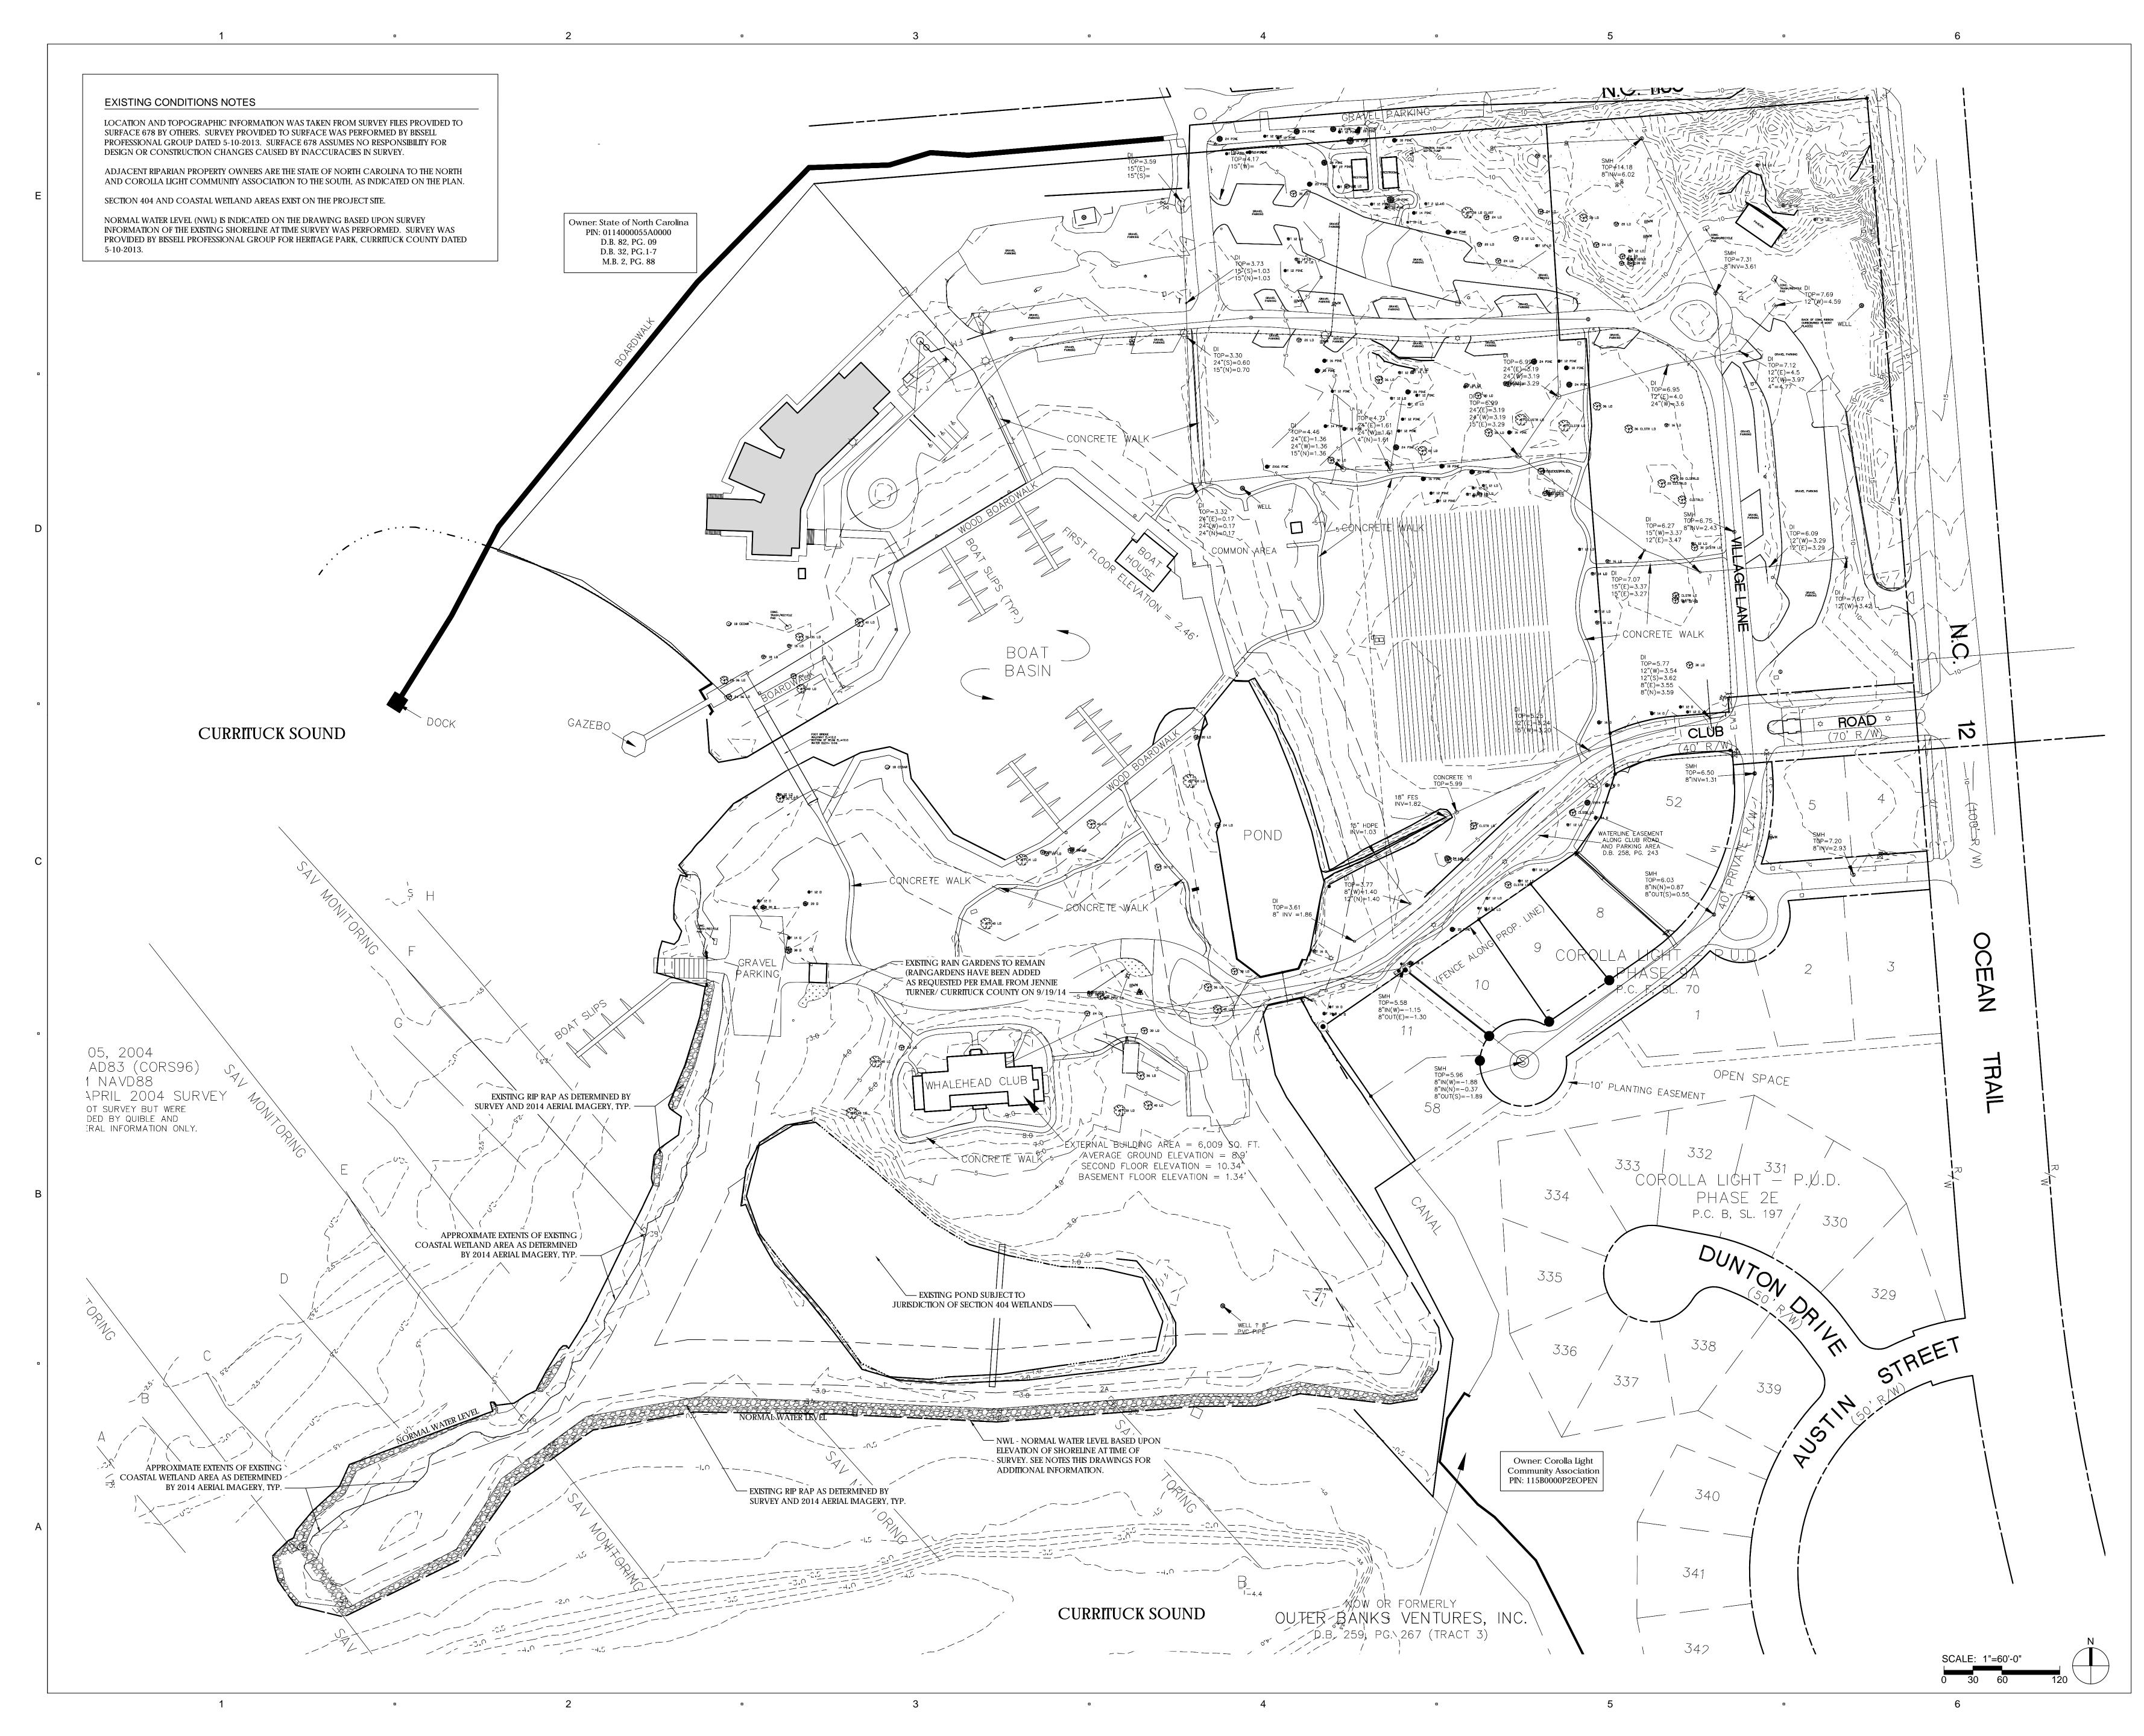



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CONSULTANTS PACE COLLABORATIVE PC. 1277 PERIMETER PKWY. VIRGINIA BEACH, VA 23454 T: 757 499 7223

REGISTRATION

CLIENT



**CURRITUCK COUNTY** 153 COURTHOUSE ROAD, SUITE 204 CURRITUCK, NC 27929



CLUB ROAD

COROLLA, NC 27927

# LANDSCAPE & PEDESTRIAN

# LANDSCAPE & PEDESTRIAN IMPROVEMENTS - PHASE I

NO.	REVISION	DATE
	SITE PLAN RESUBMITTAL	10.16.14
2	BID FOR CONSTRUCTION	12.19.14
ISSUE		
CONS	STRUCTION DO	CUMENTS
PROJE	CT NO:	A0000
DATE:	DECEMBE	R 19, 2014
DRAW	N:	JI, KL, RP


EXISTING CONDITIONS

L000

CHECKED:


SHEET TITLE:

RP, ED

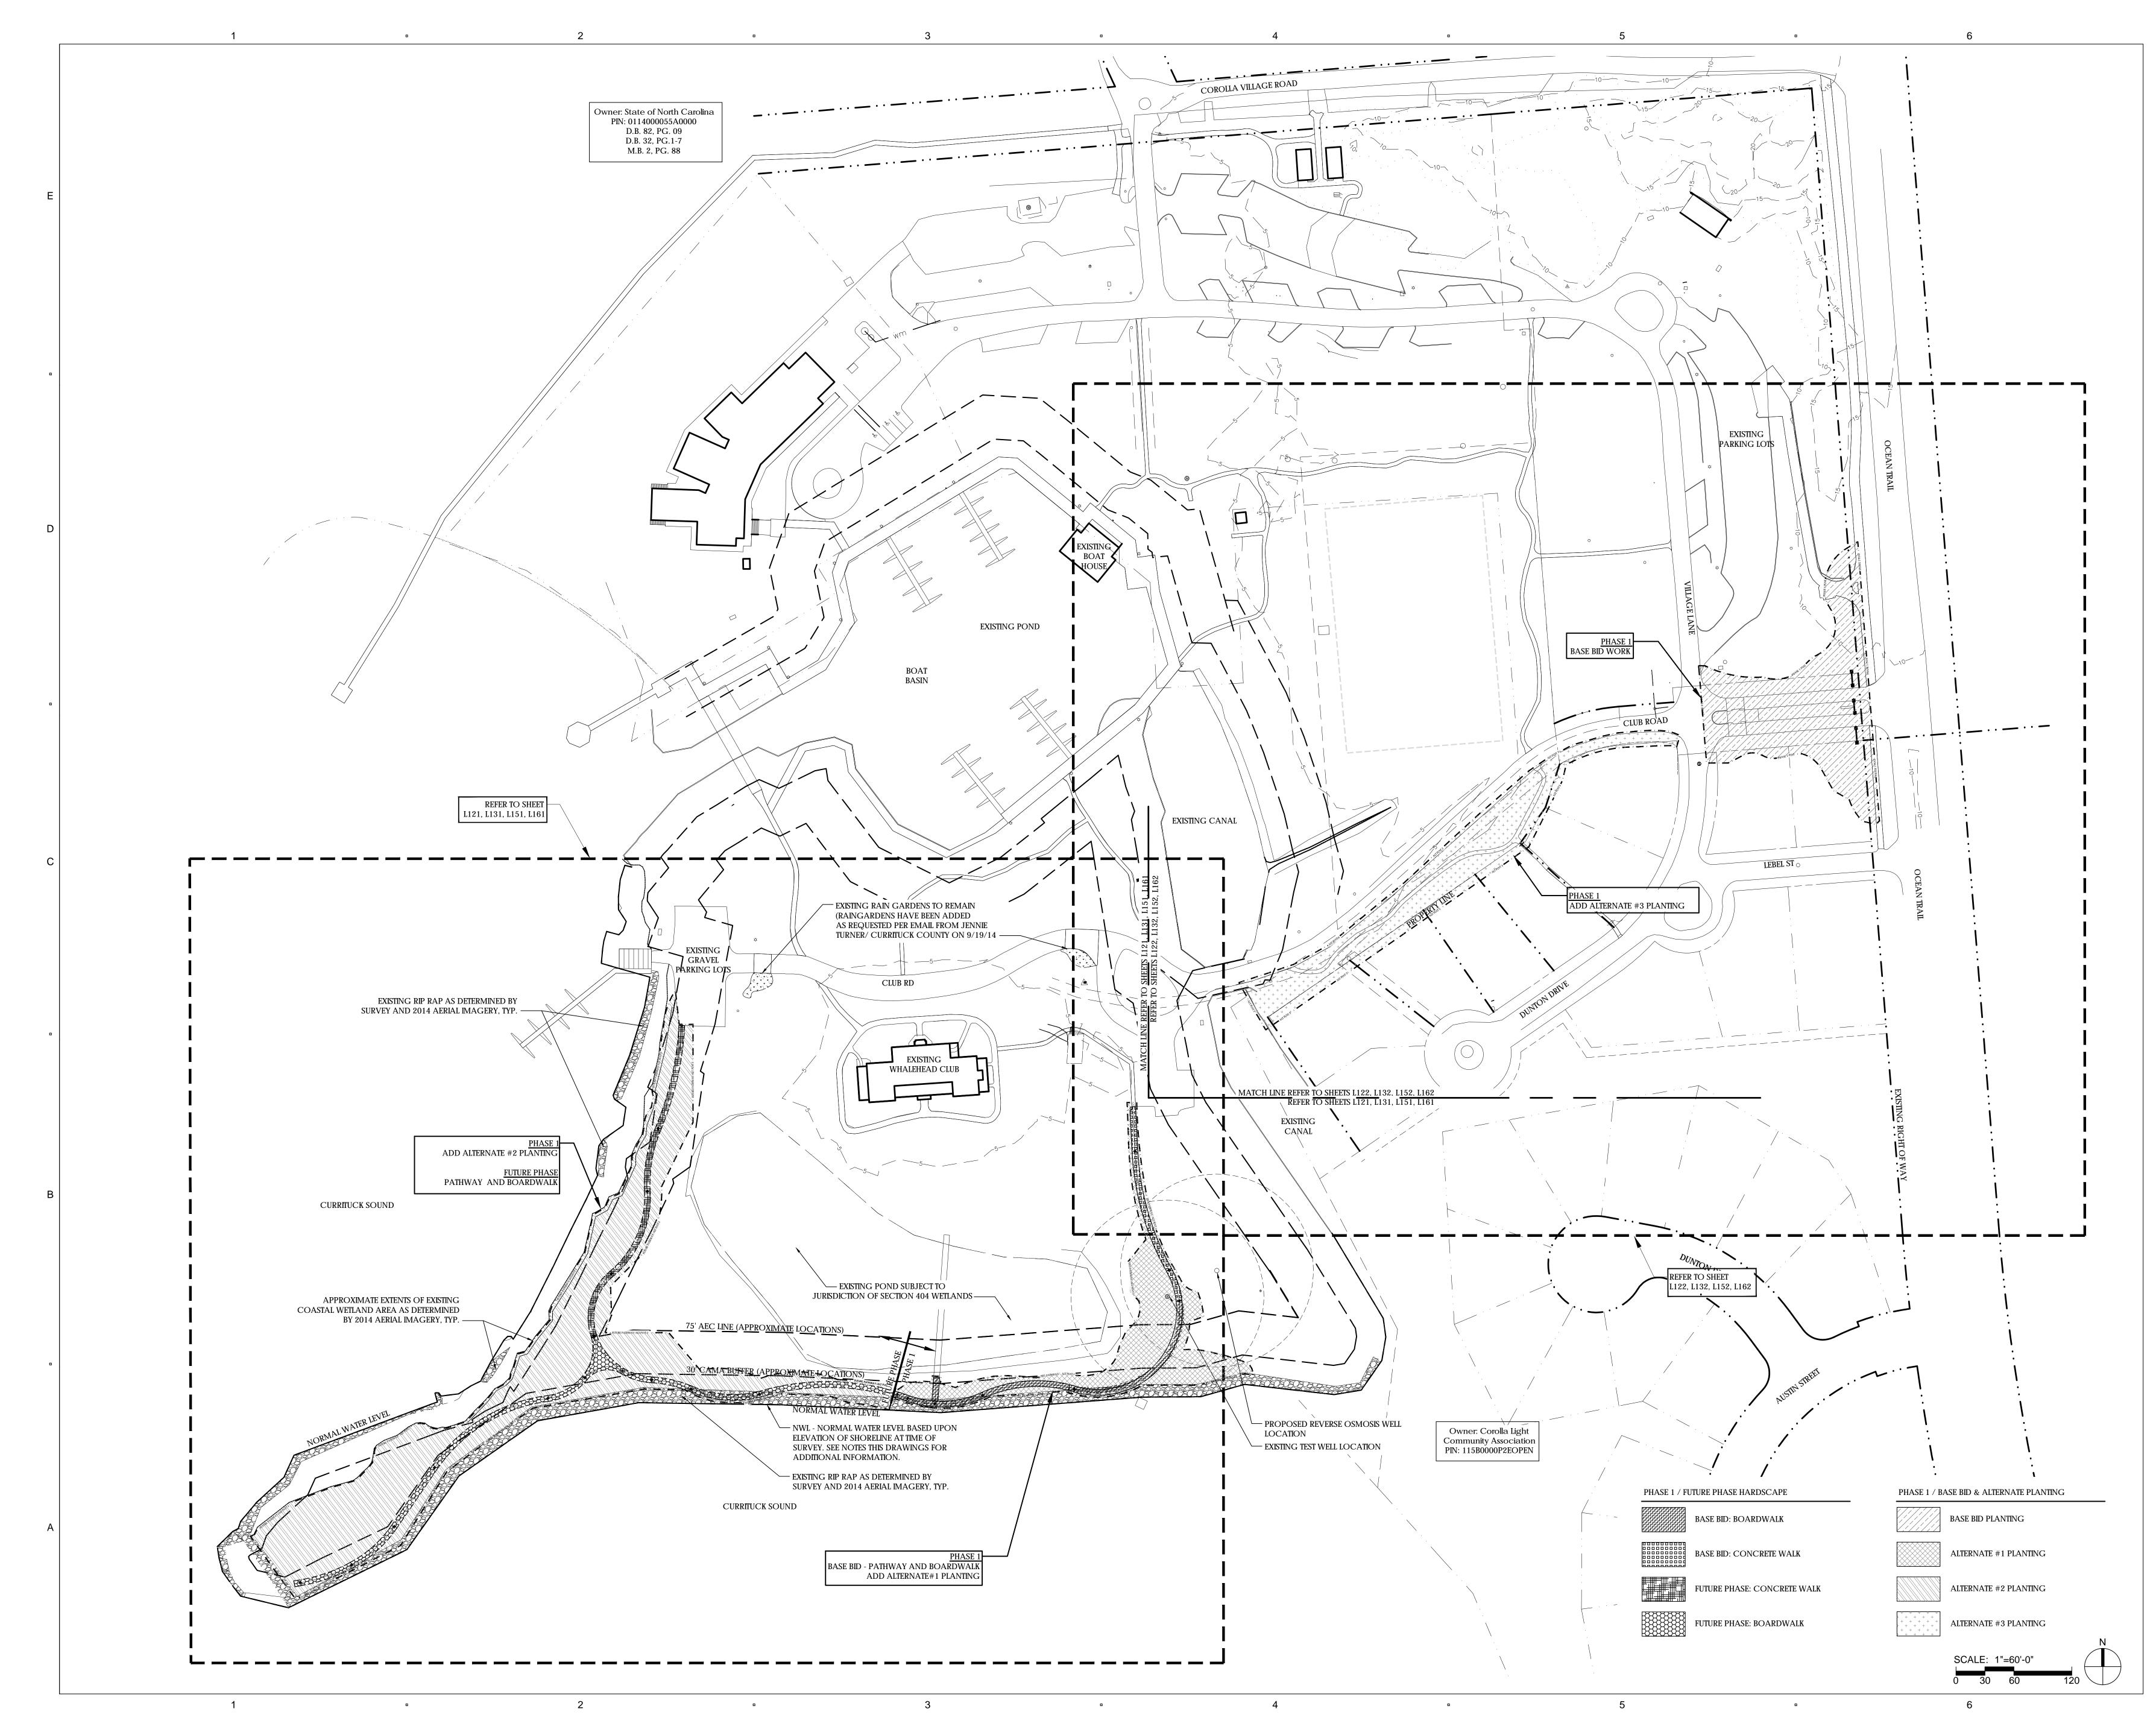



CONSULTANTS PACE COLLABORATIVE PC. 1277 PERIMETER PKWY. VIRGINIA BEACH, VA 23454 T: 757 499 7223

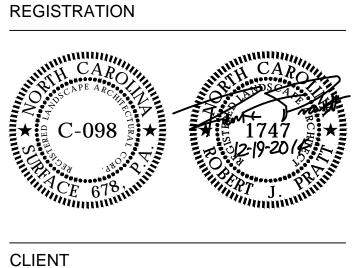




#### **CURRITUCK COUNTY** 153 COURTHOUSE ROAD, SUITE 204 CURRITUCK, NC 27929




#### CLUB ROAD COROLLA, NC 27927

# LANDSCAPE & PEDESTRIAN IMPROVEMENTS - PHASE I


NO.	REVISION	DATE
1	SITE PLAN RESUBMITTAL	10.16.14
2	BID FOR CONSTRUCTION	12.19.14
	1	_
ISSUE	:	
CONS	STRUCTION DOC	CUMENTS
PROJE	ECT NO:	A0000
DATE:	DECEMBER	R 19, 2014
DRAW	N:	JI, KL, RP
CHEC	KED:	RP, ED
SHEET	TITLE:	
SIT	E CONTEXT	/
	ET EXTENT	
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DEMOLITION PLAN

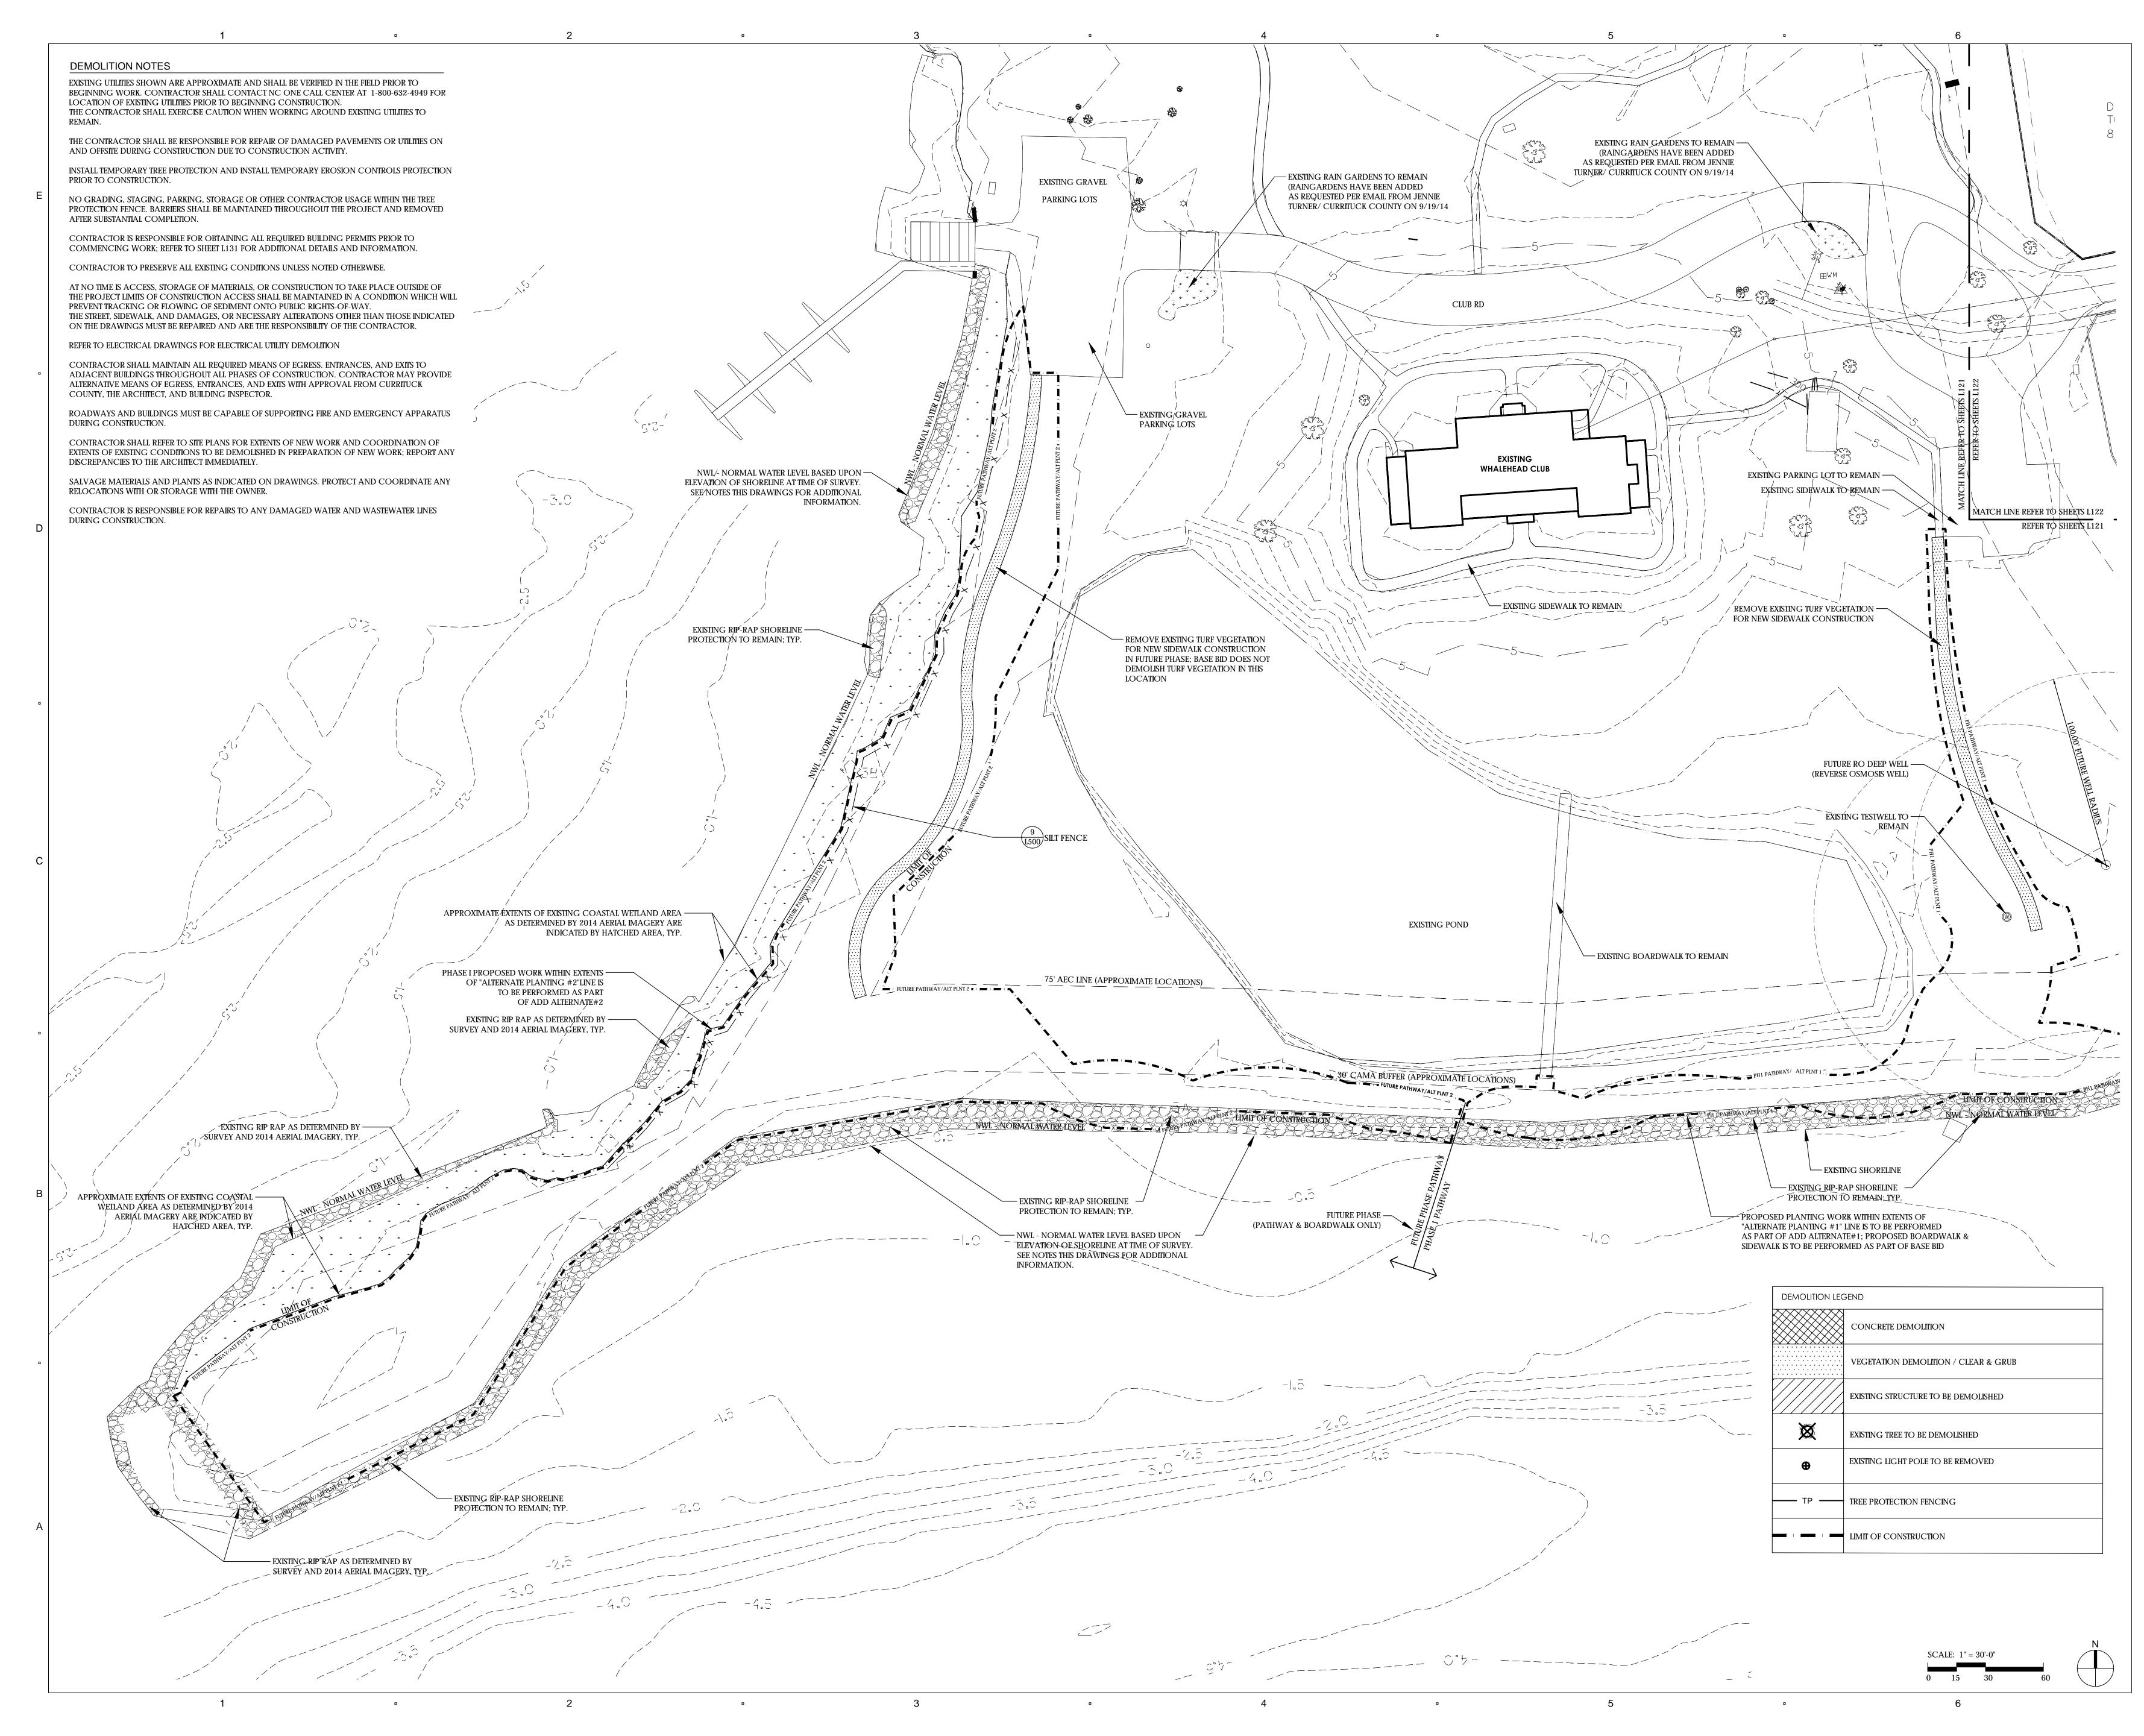

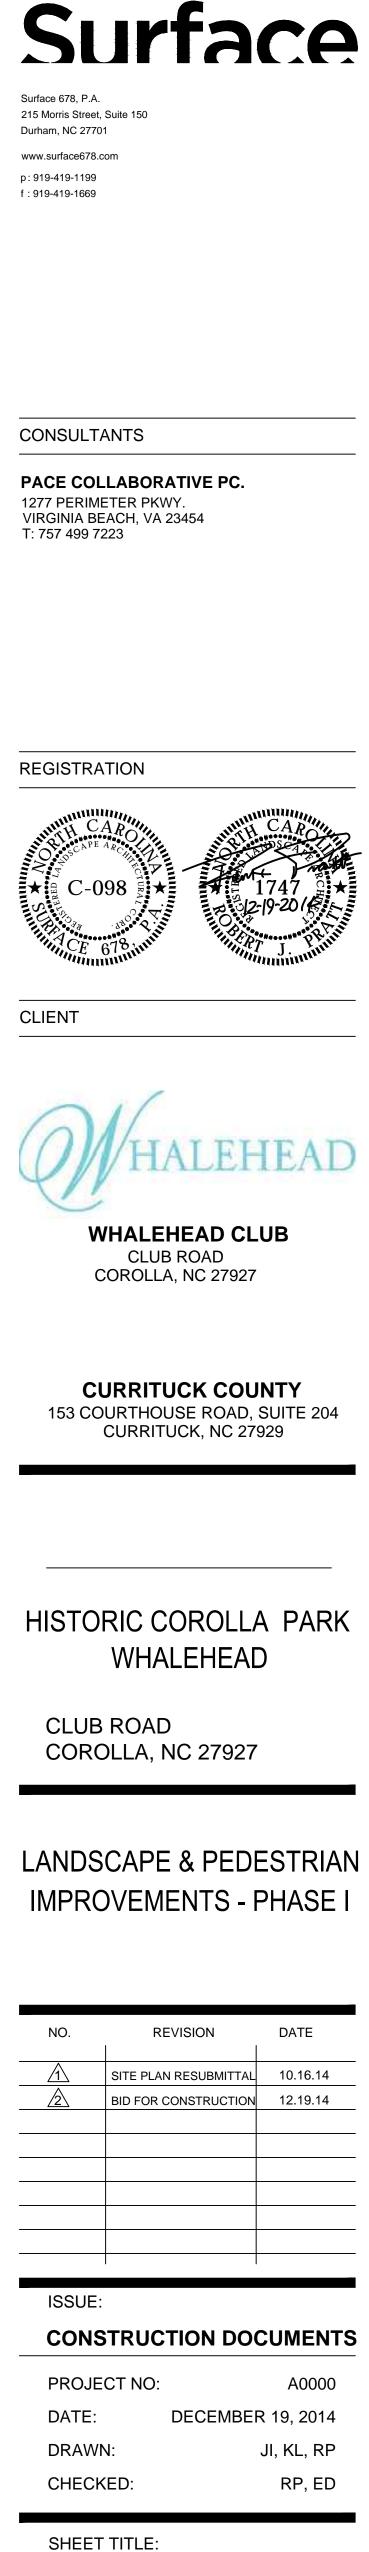


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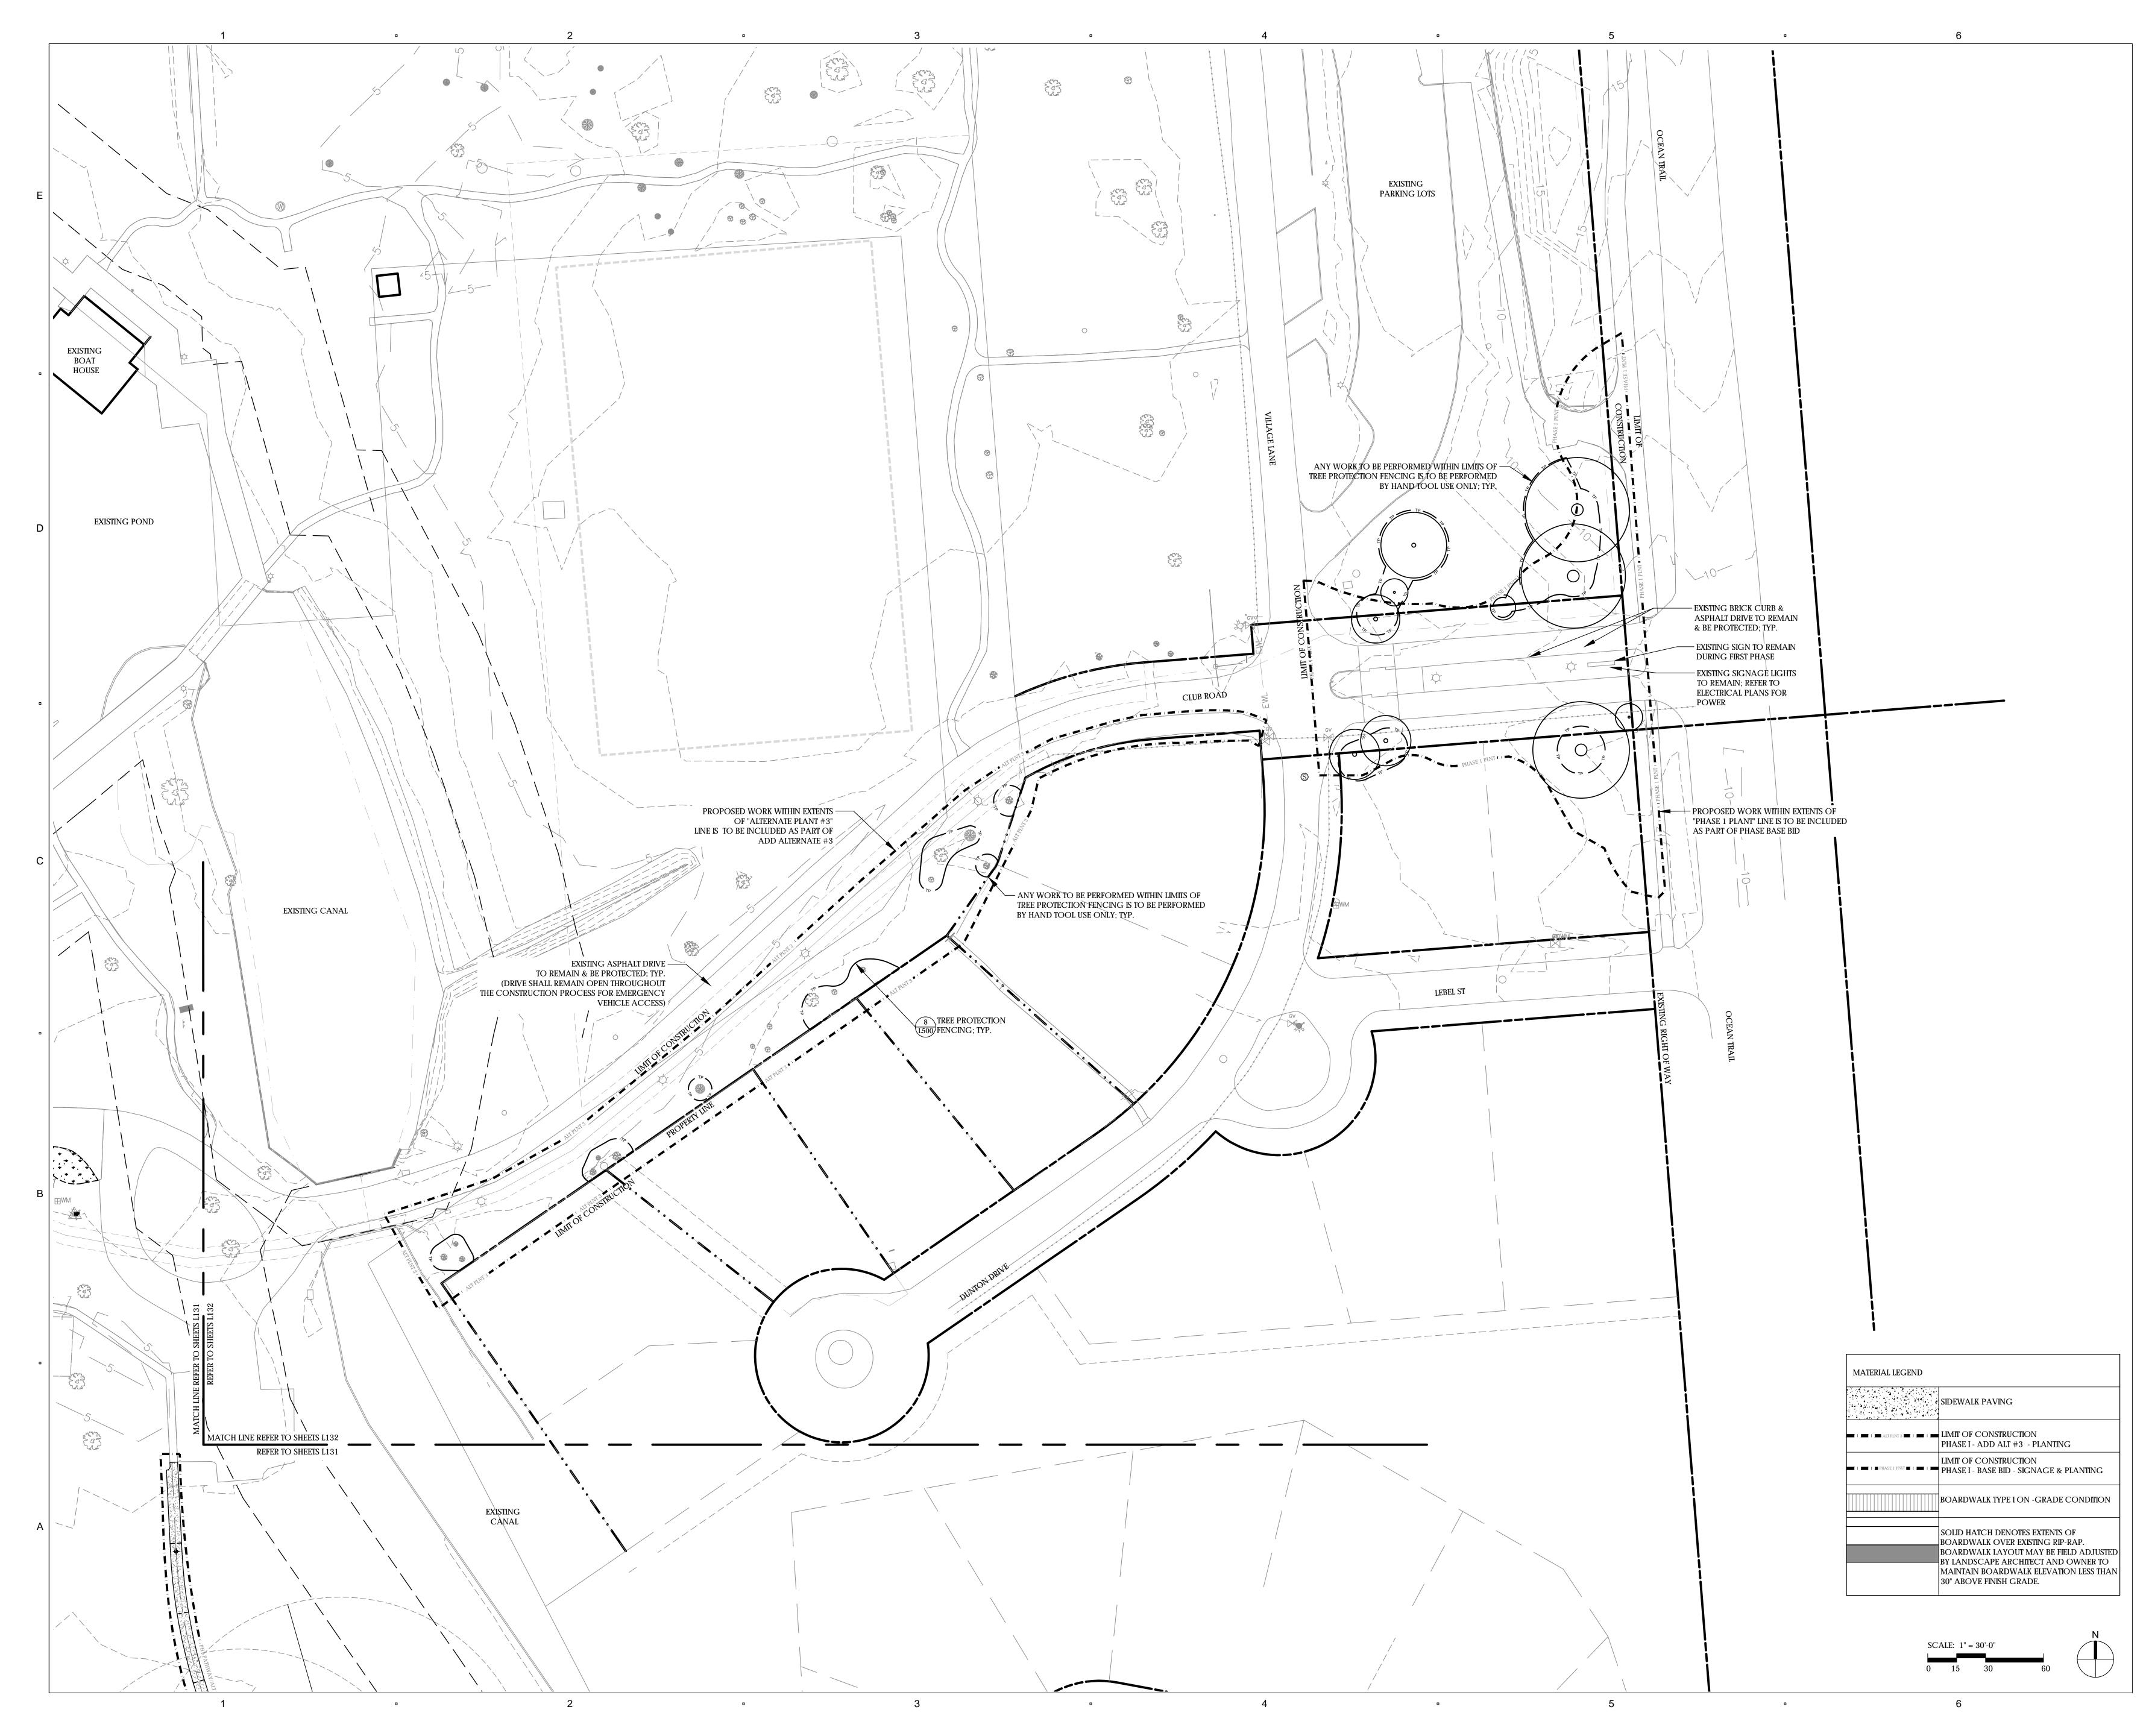


DEMOLITION PLAN

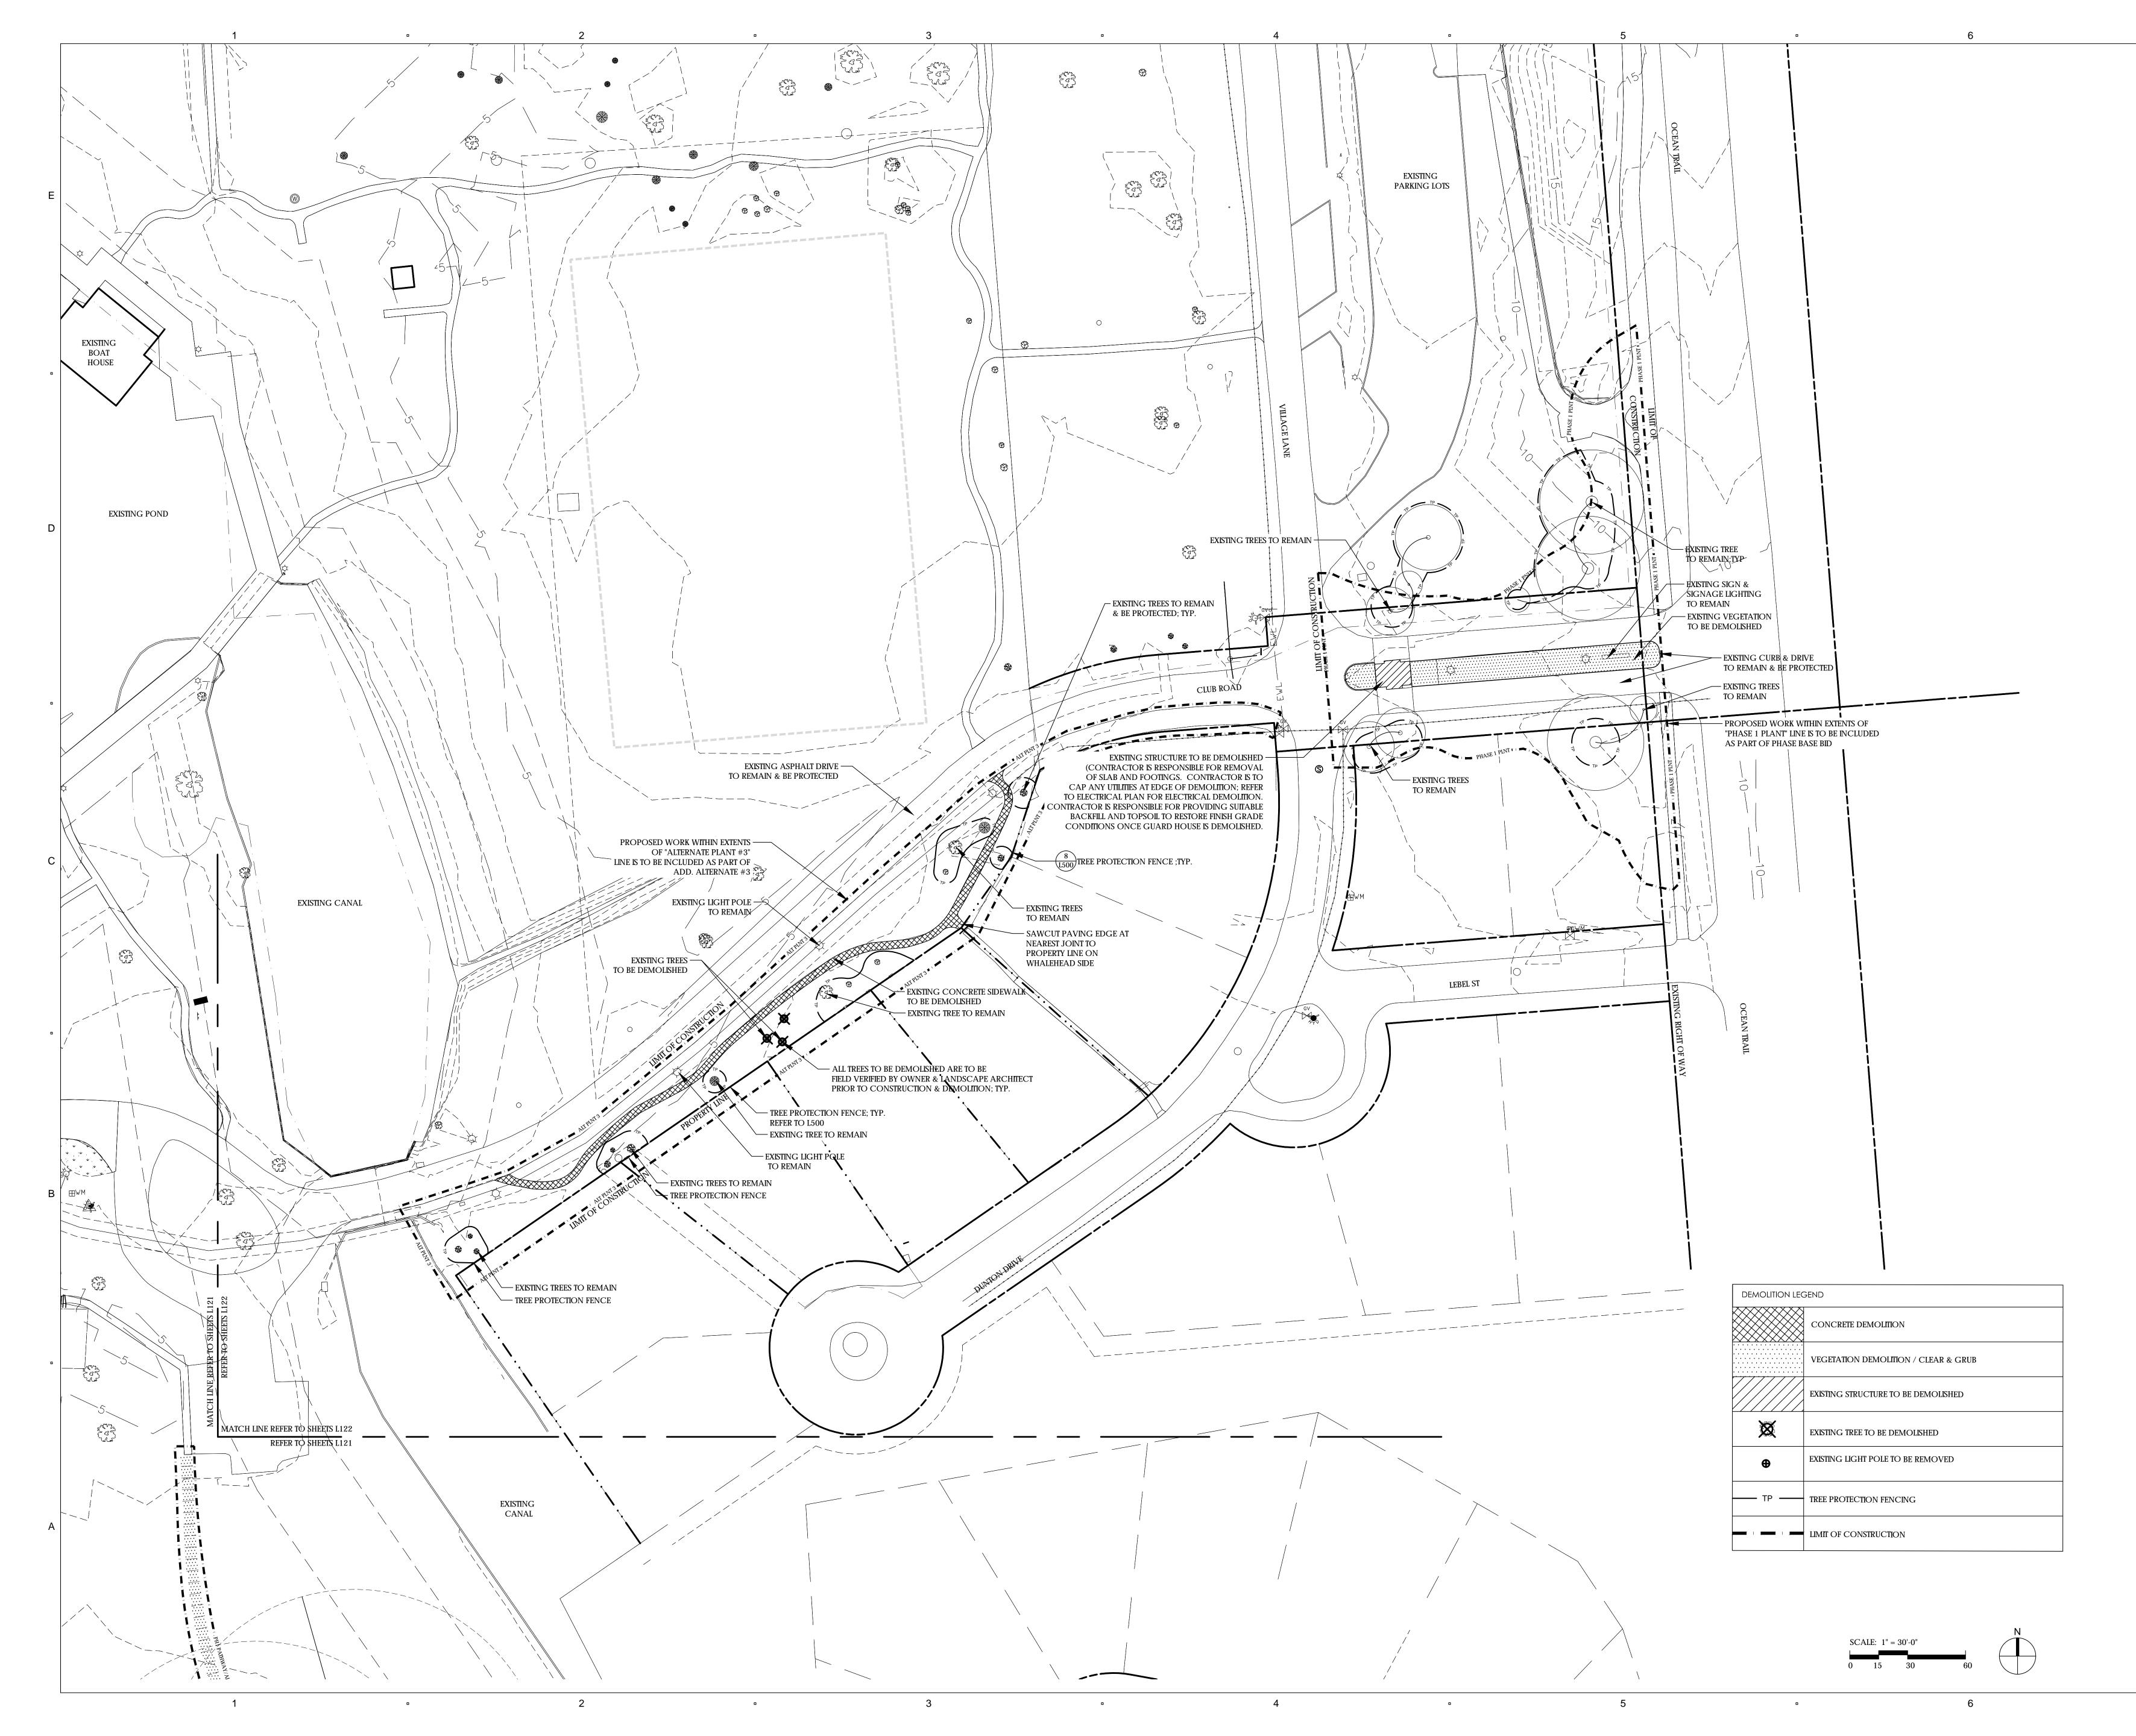





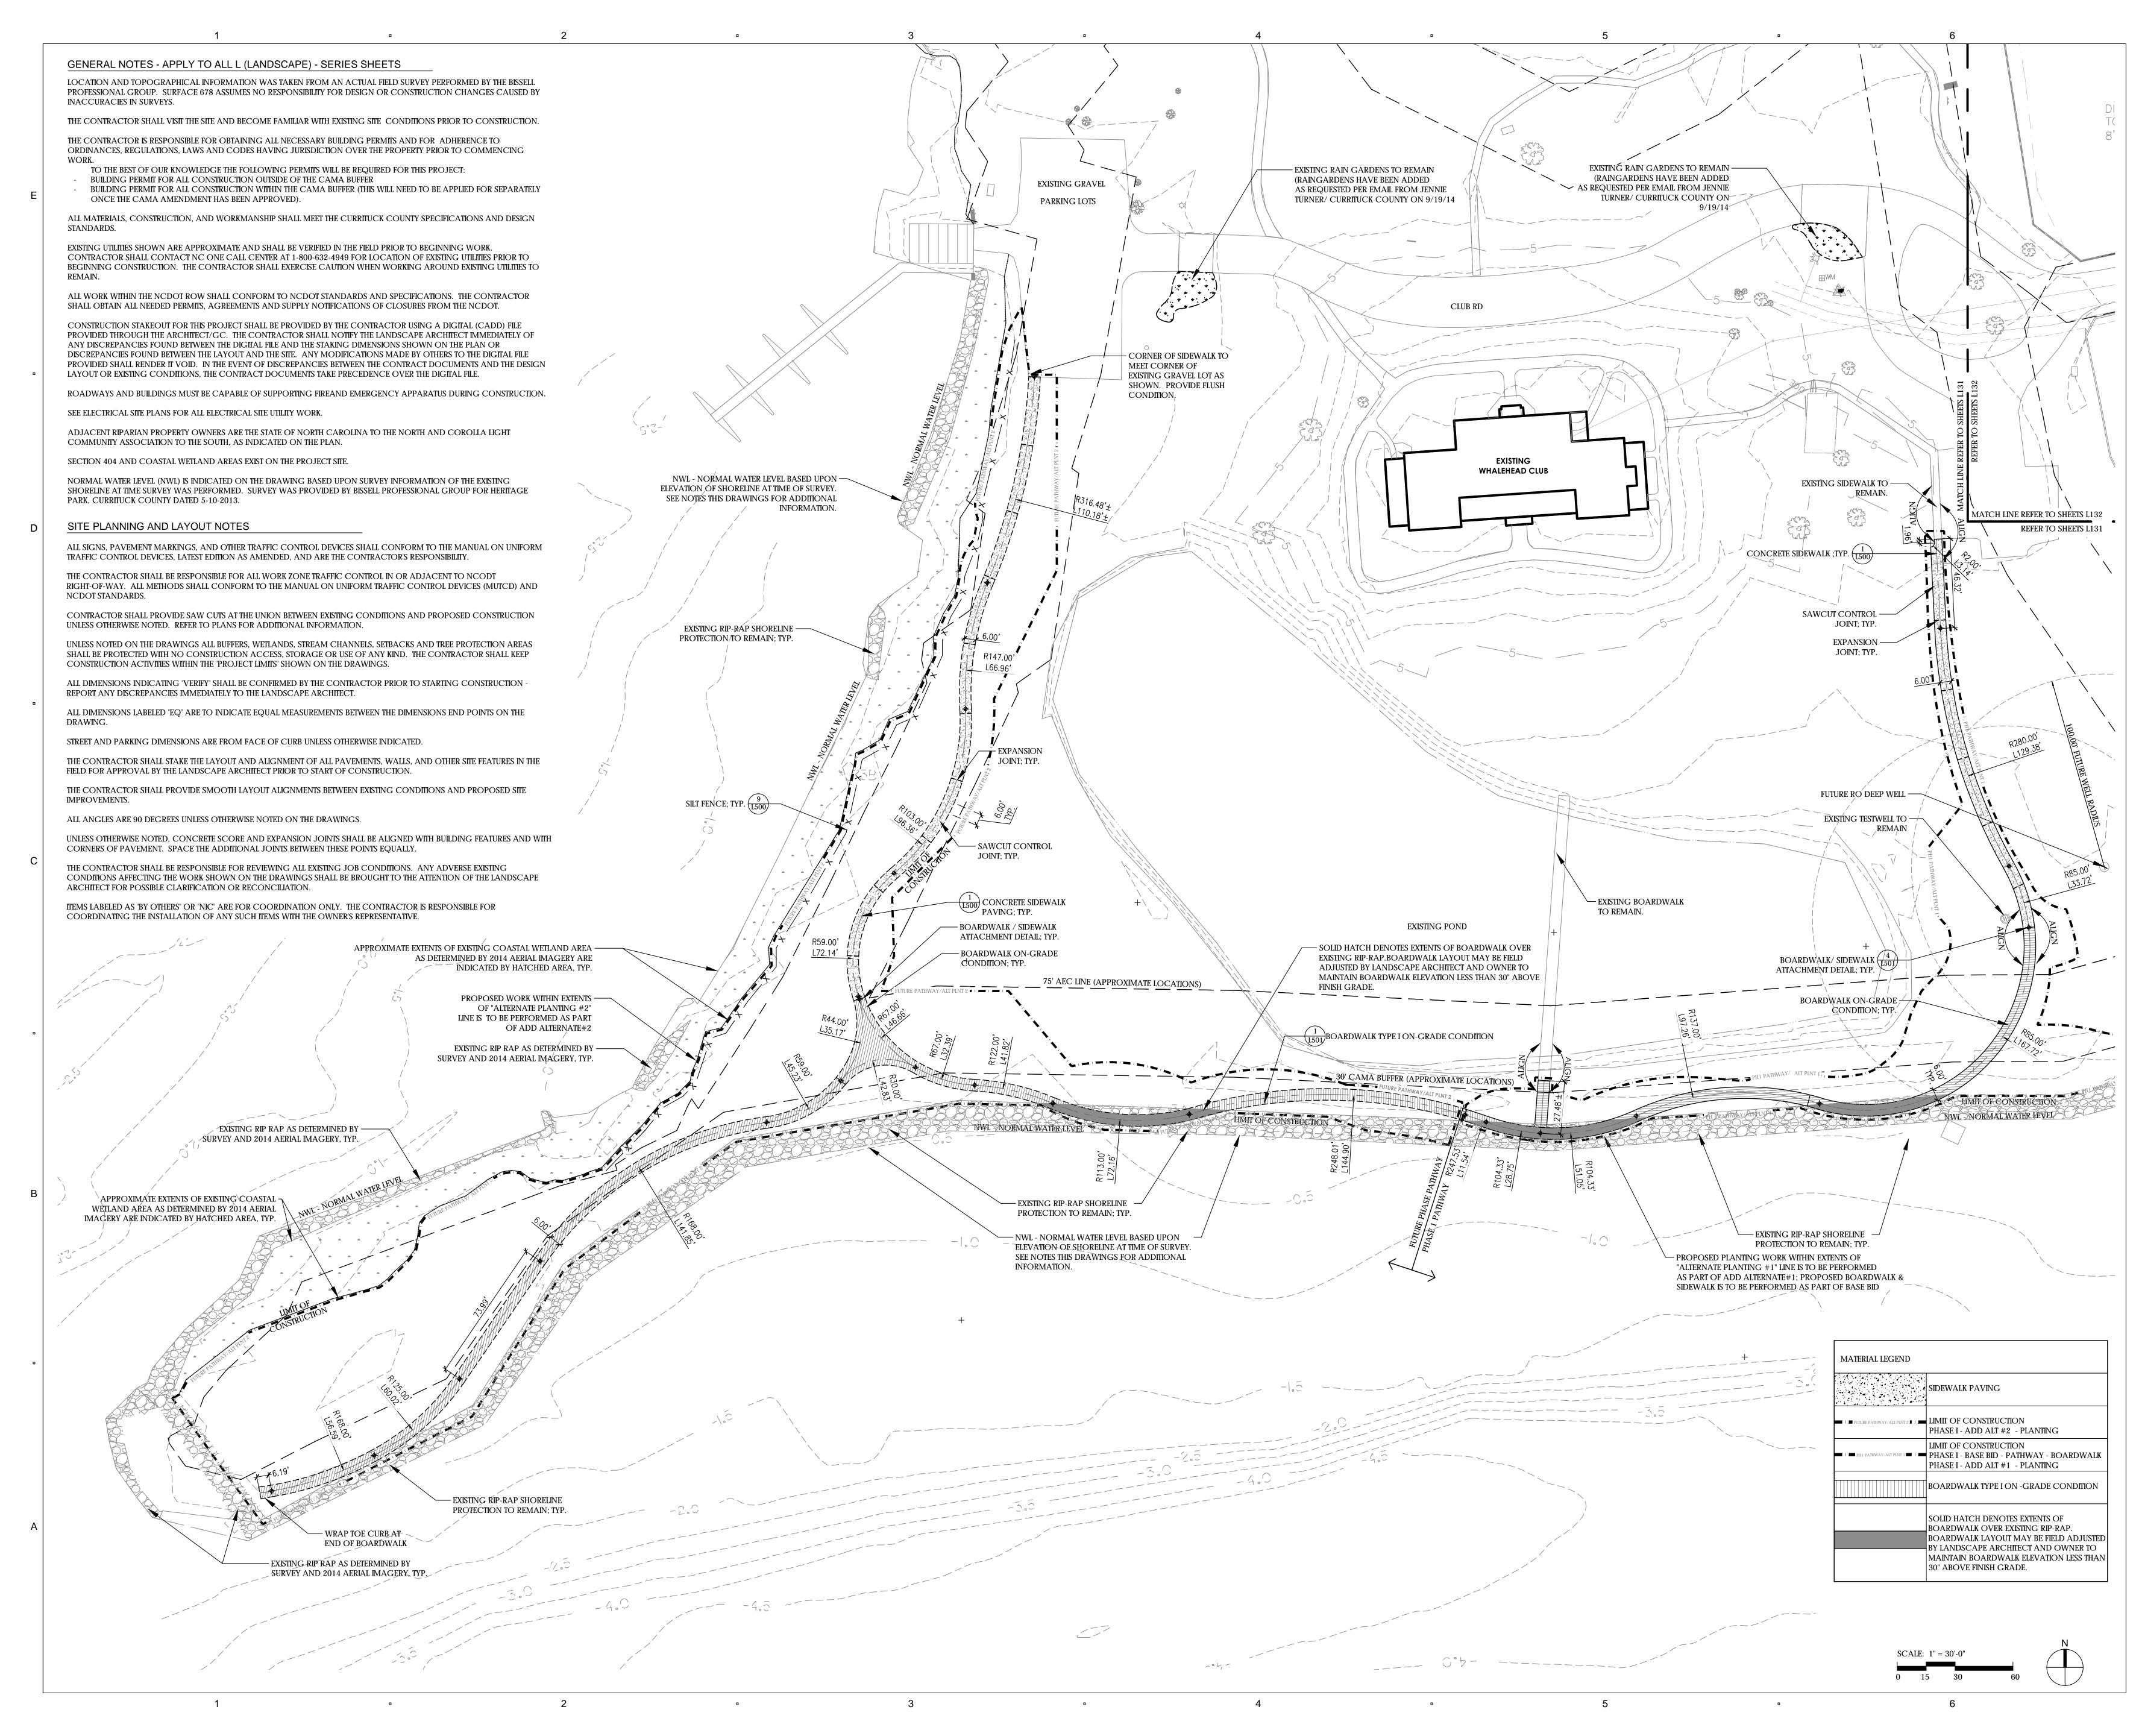





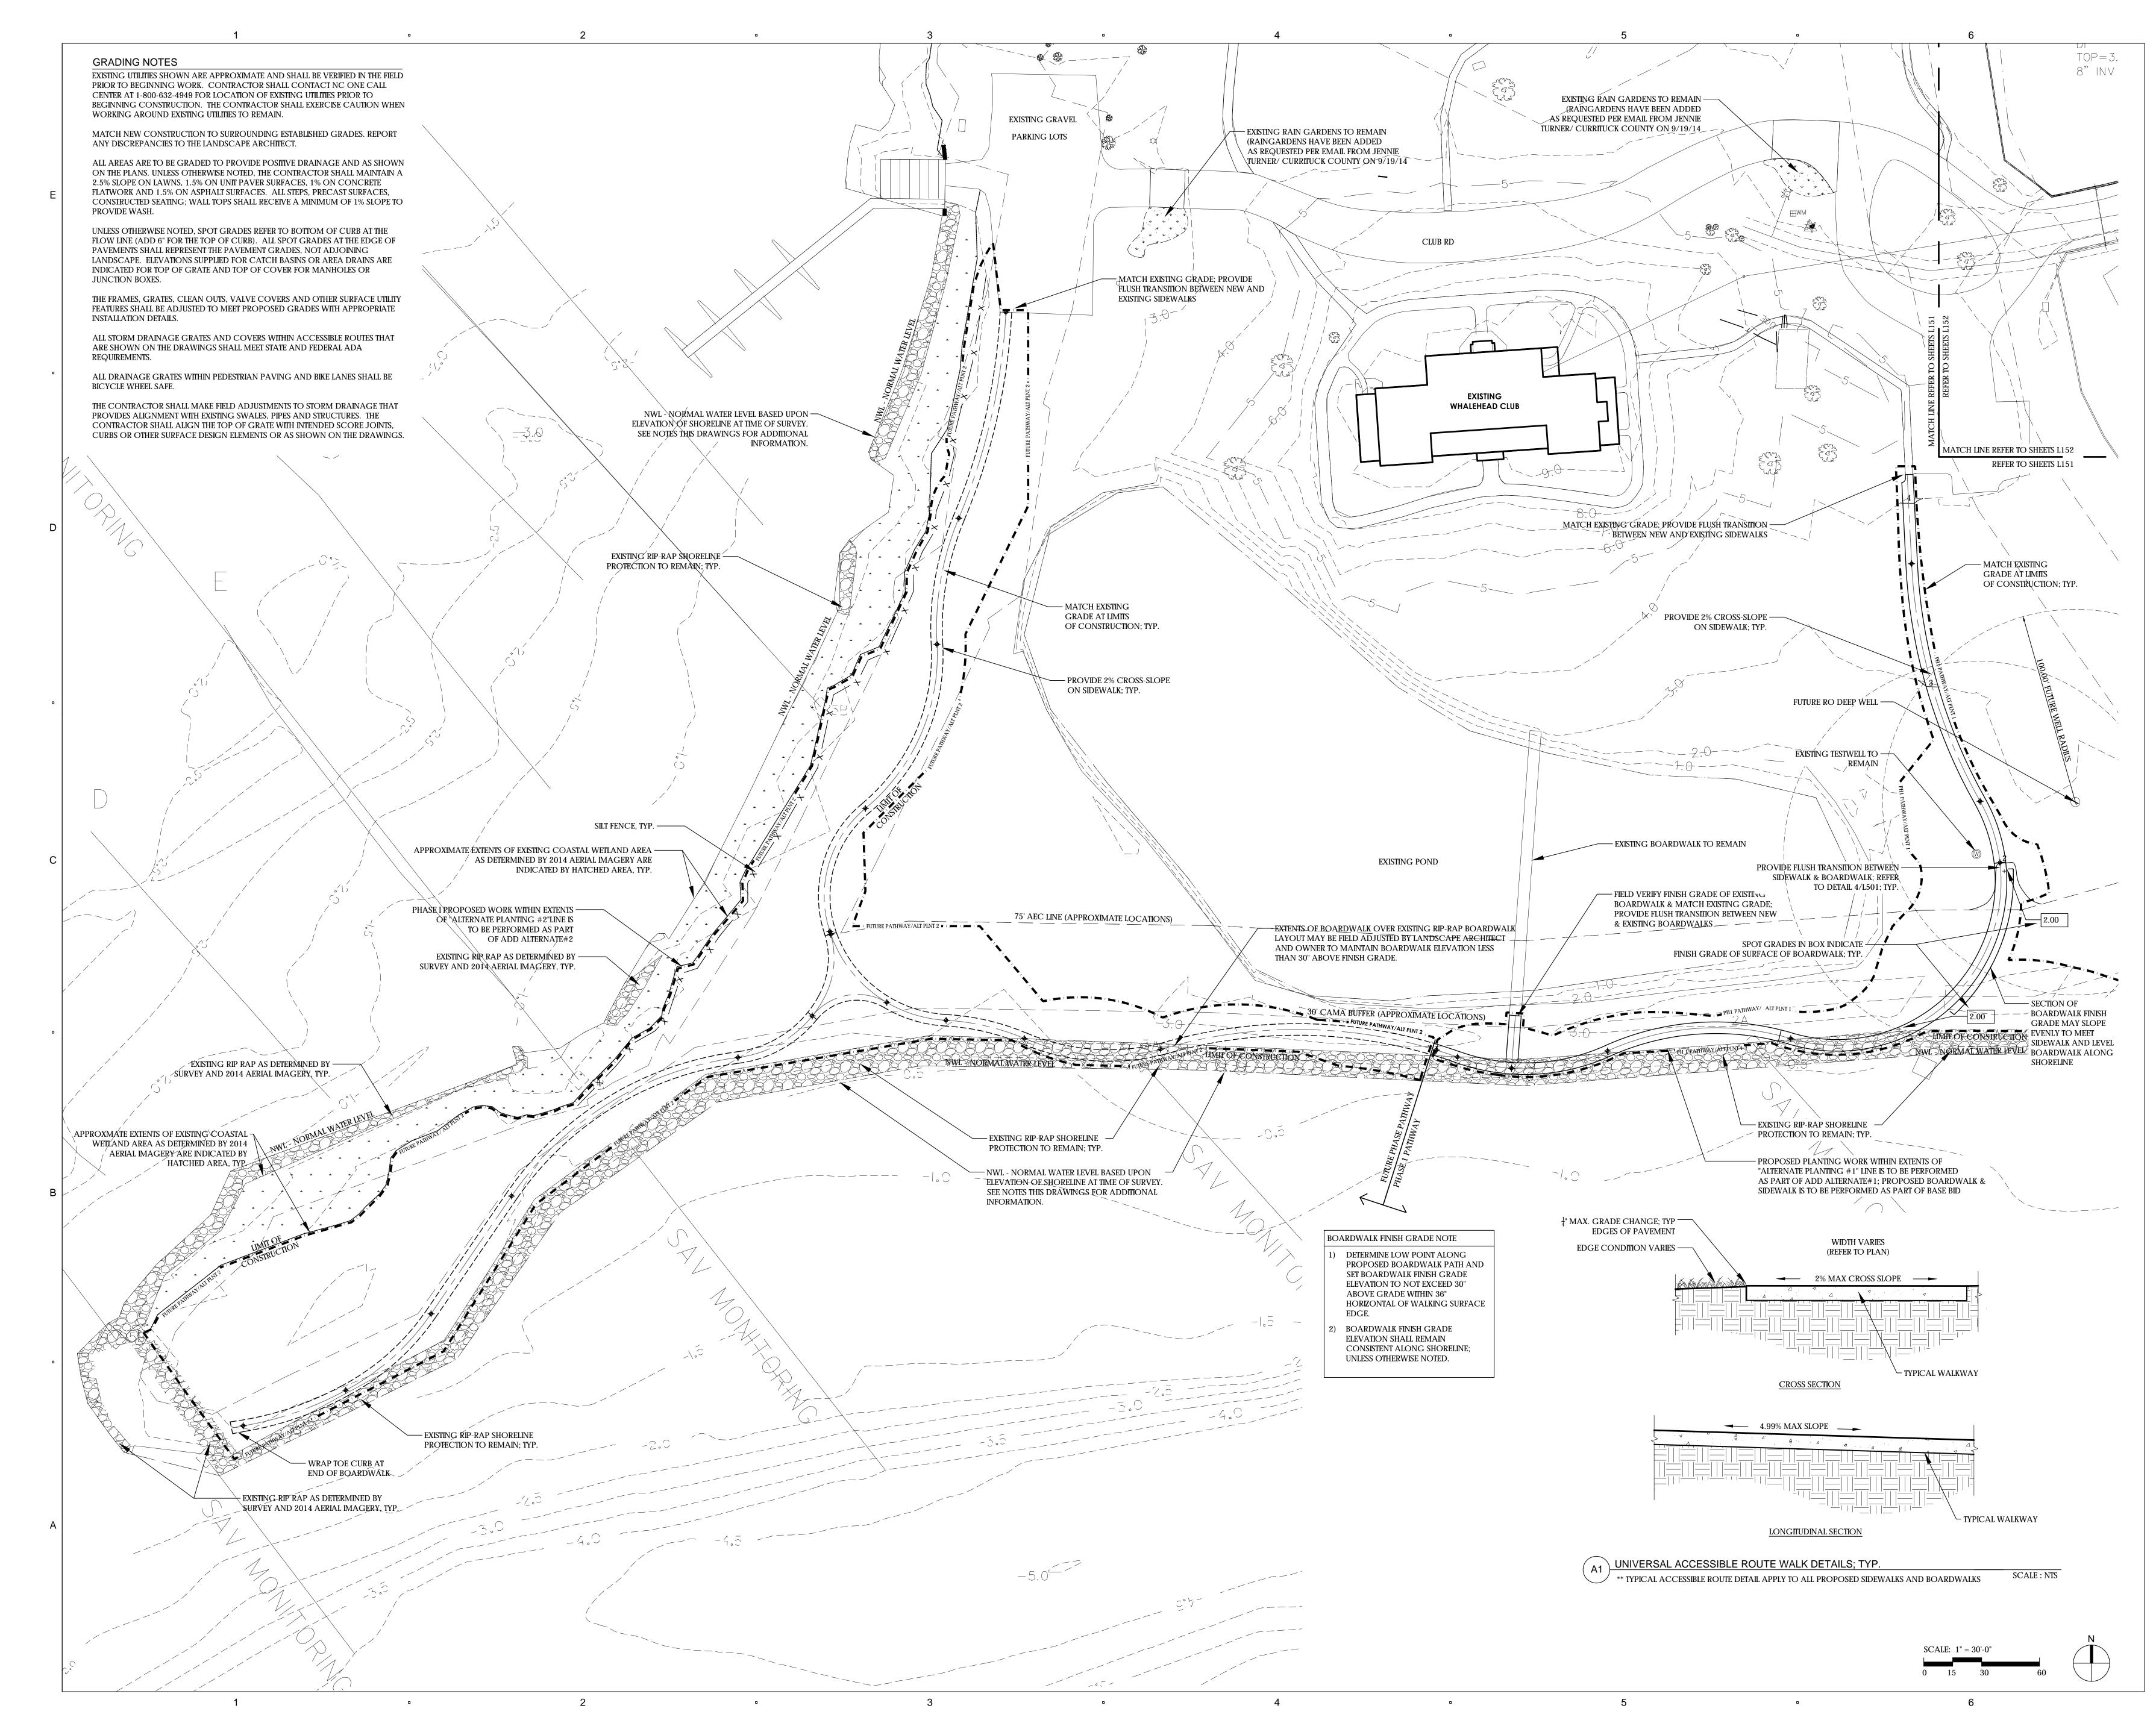


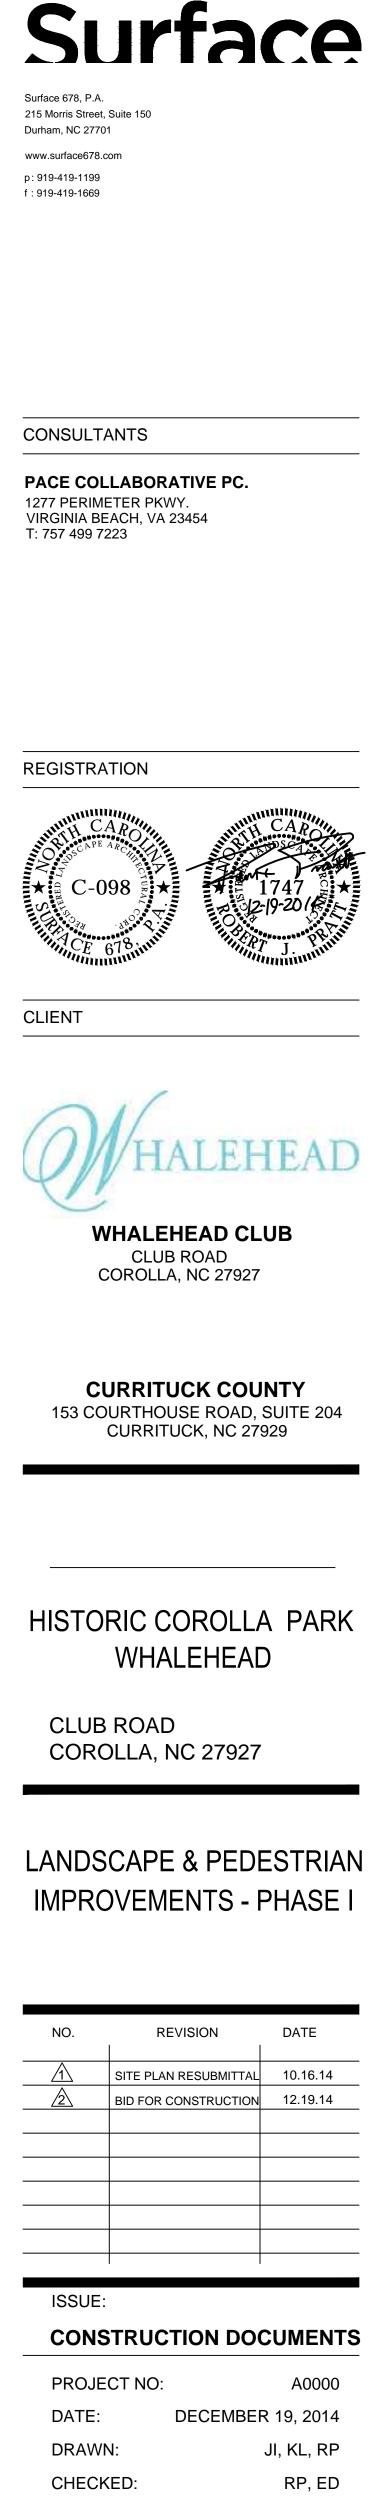


SHEET TITLE:

GRADING PLAN

L151

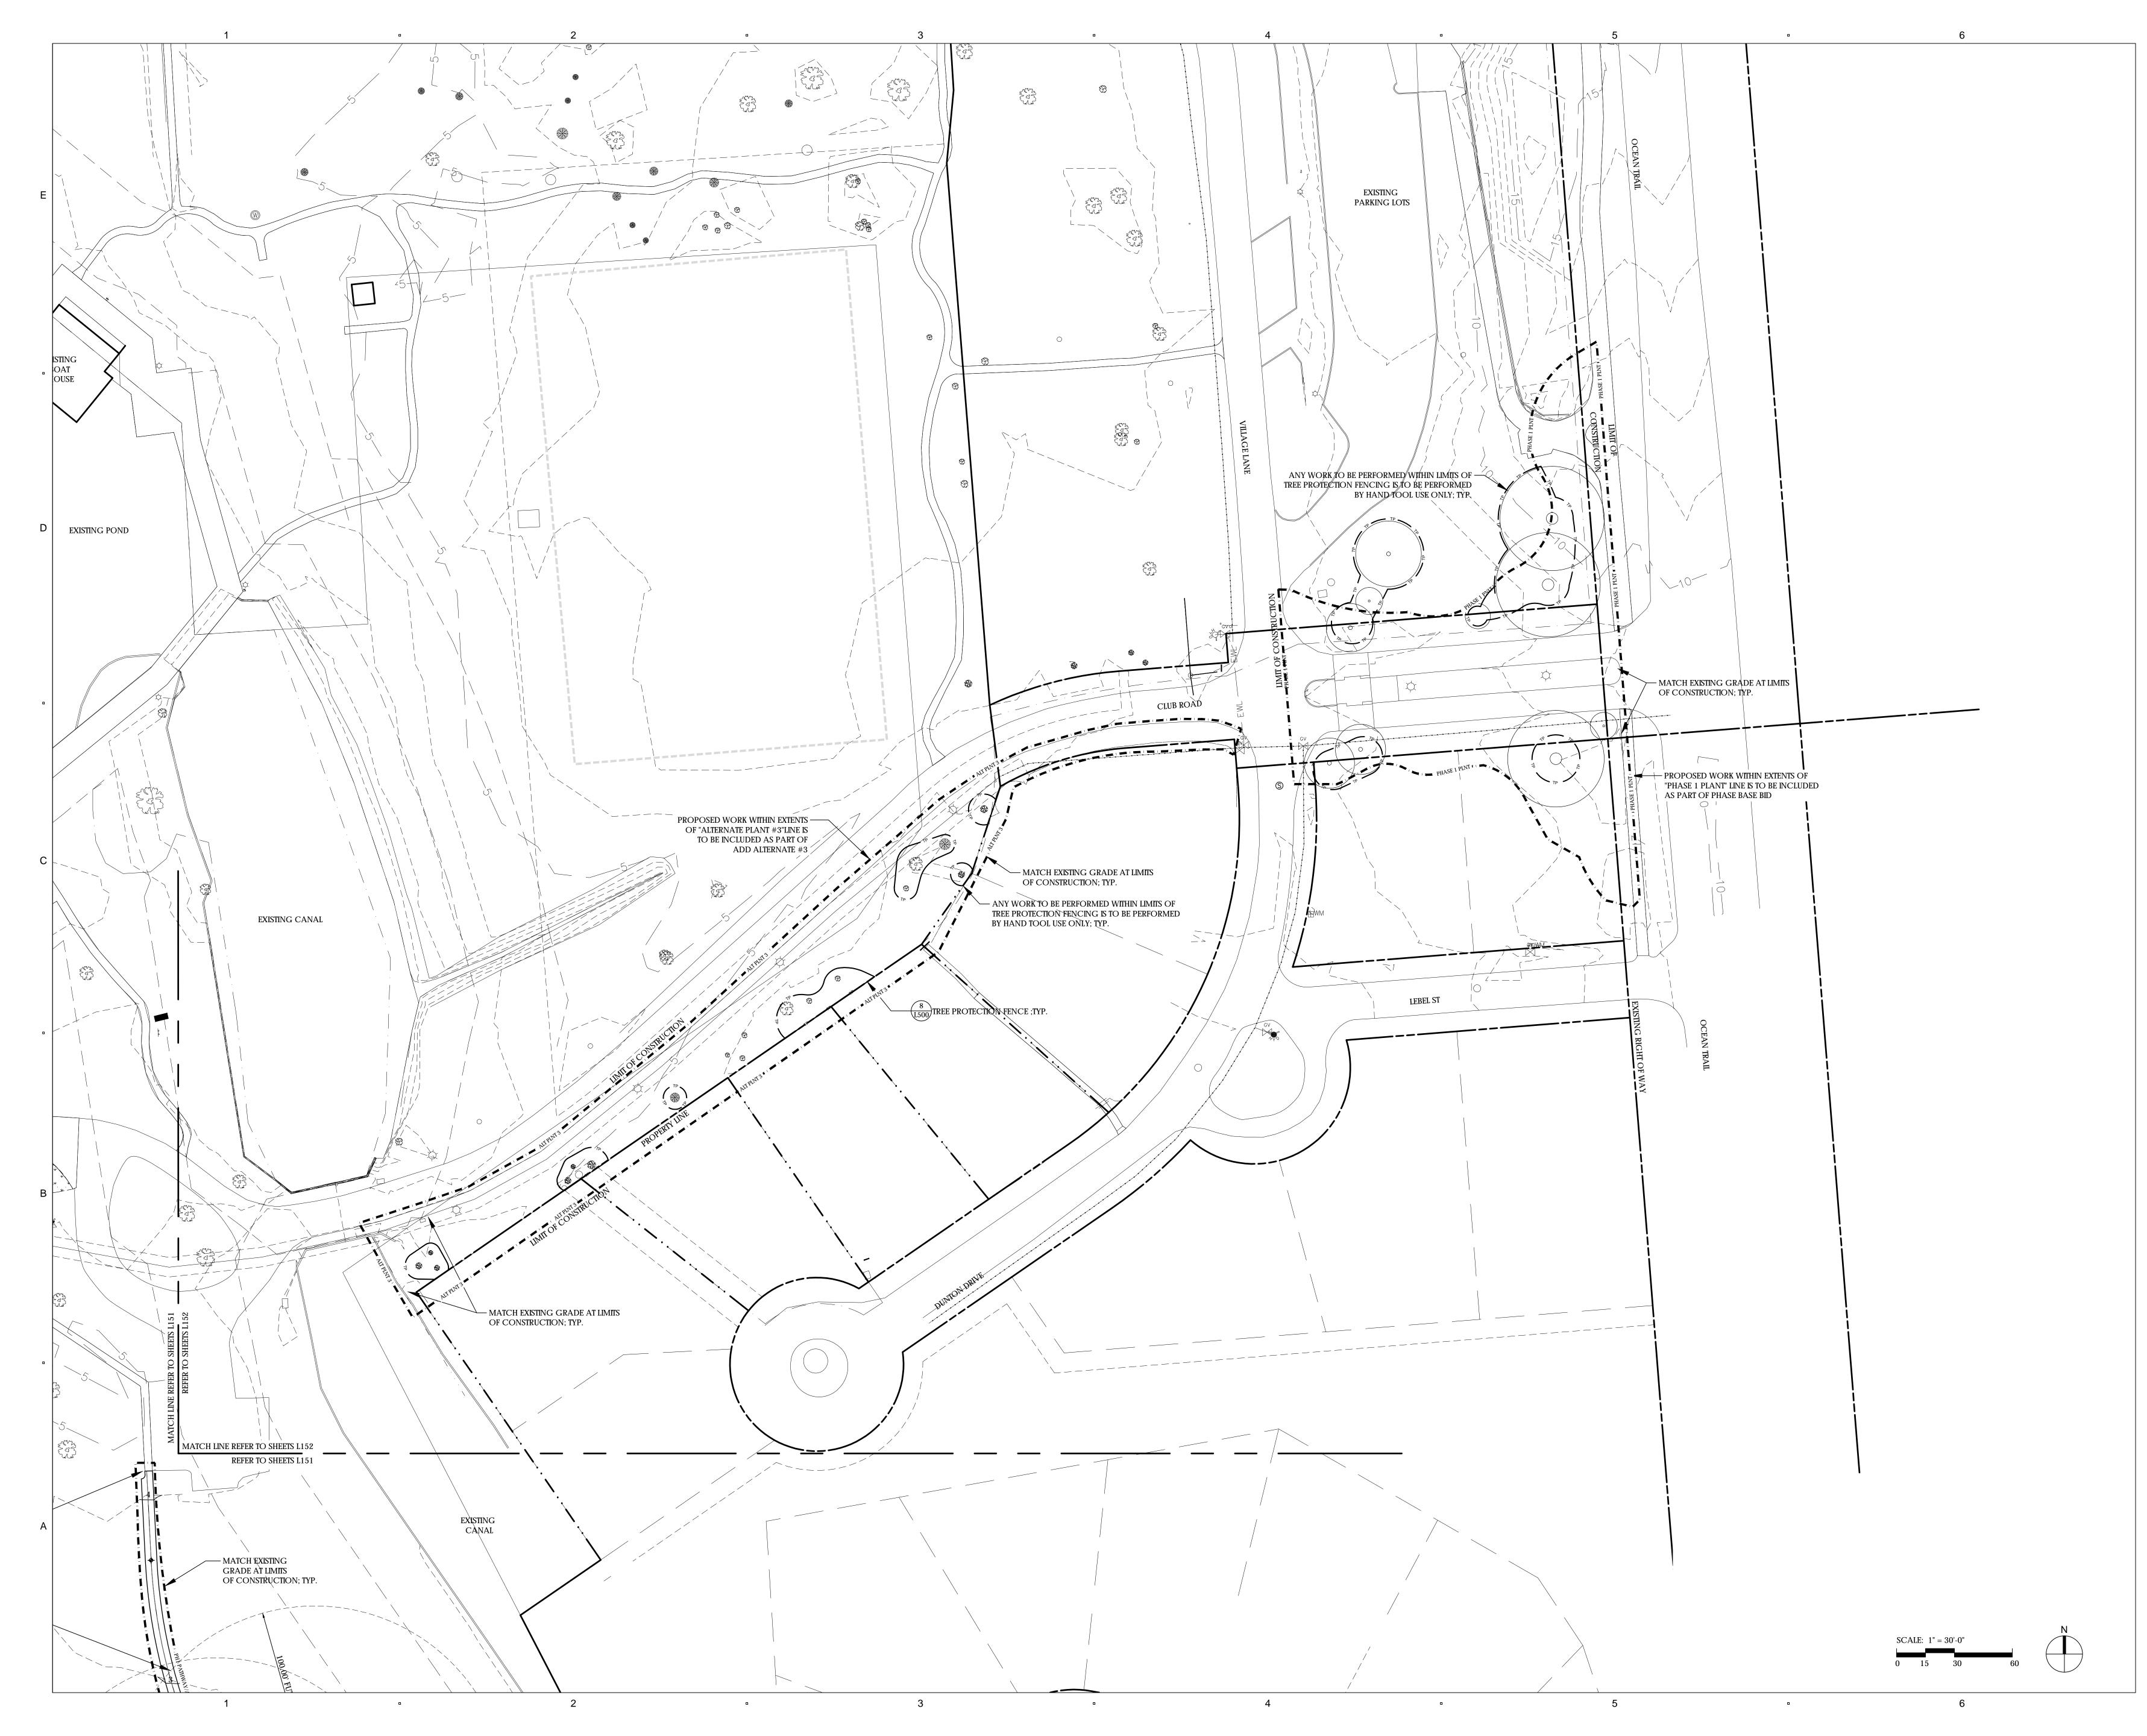


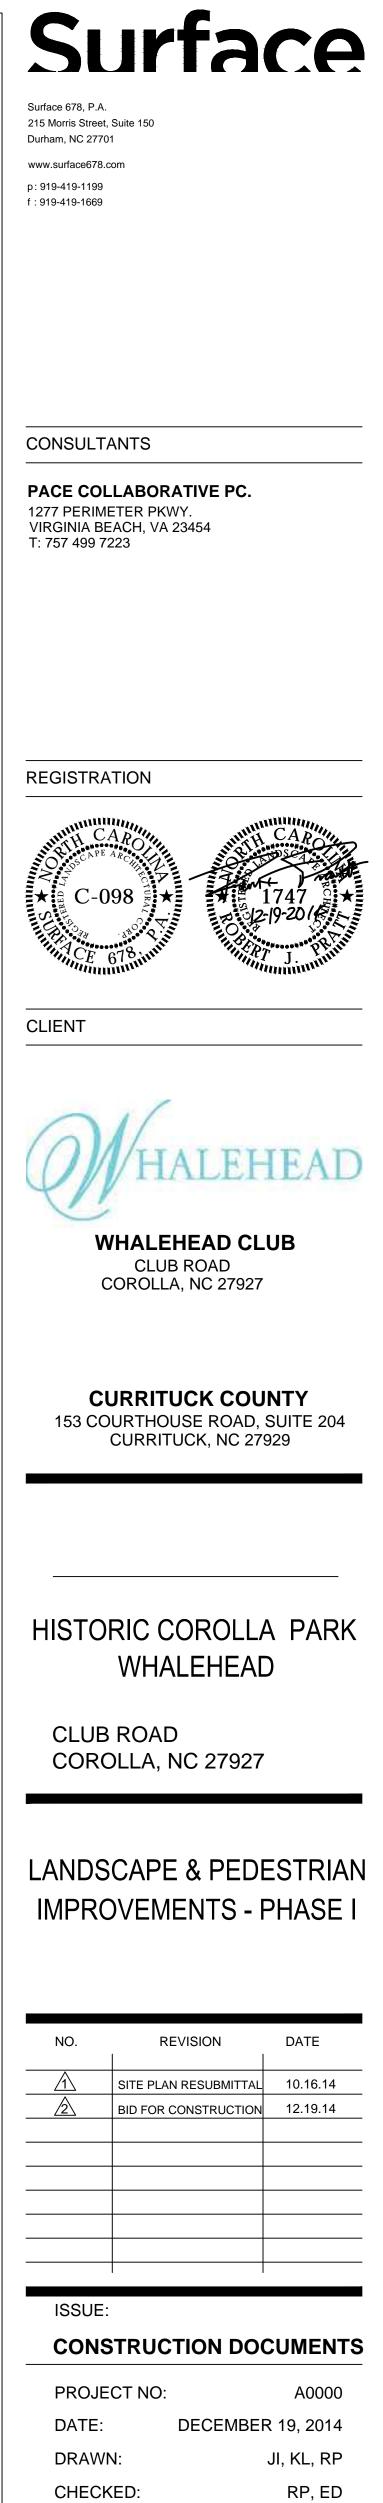

SHEET TITLE:

GRADING PLAN

L152

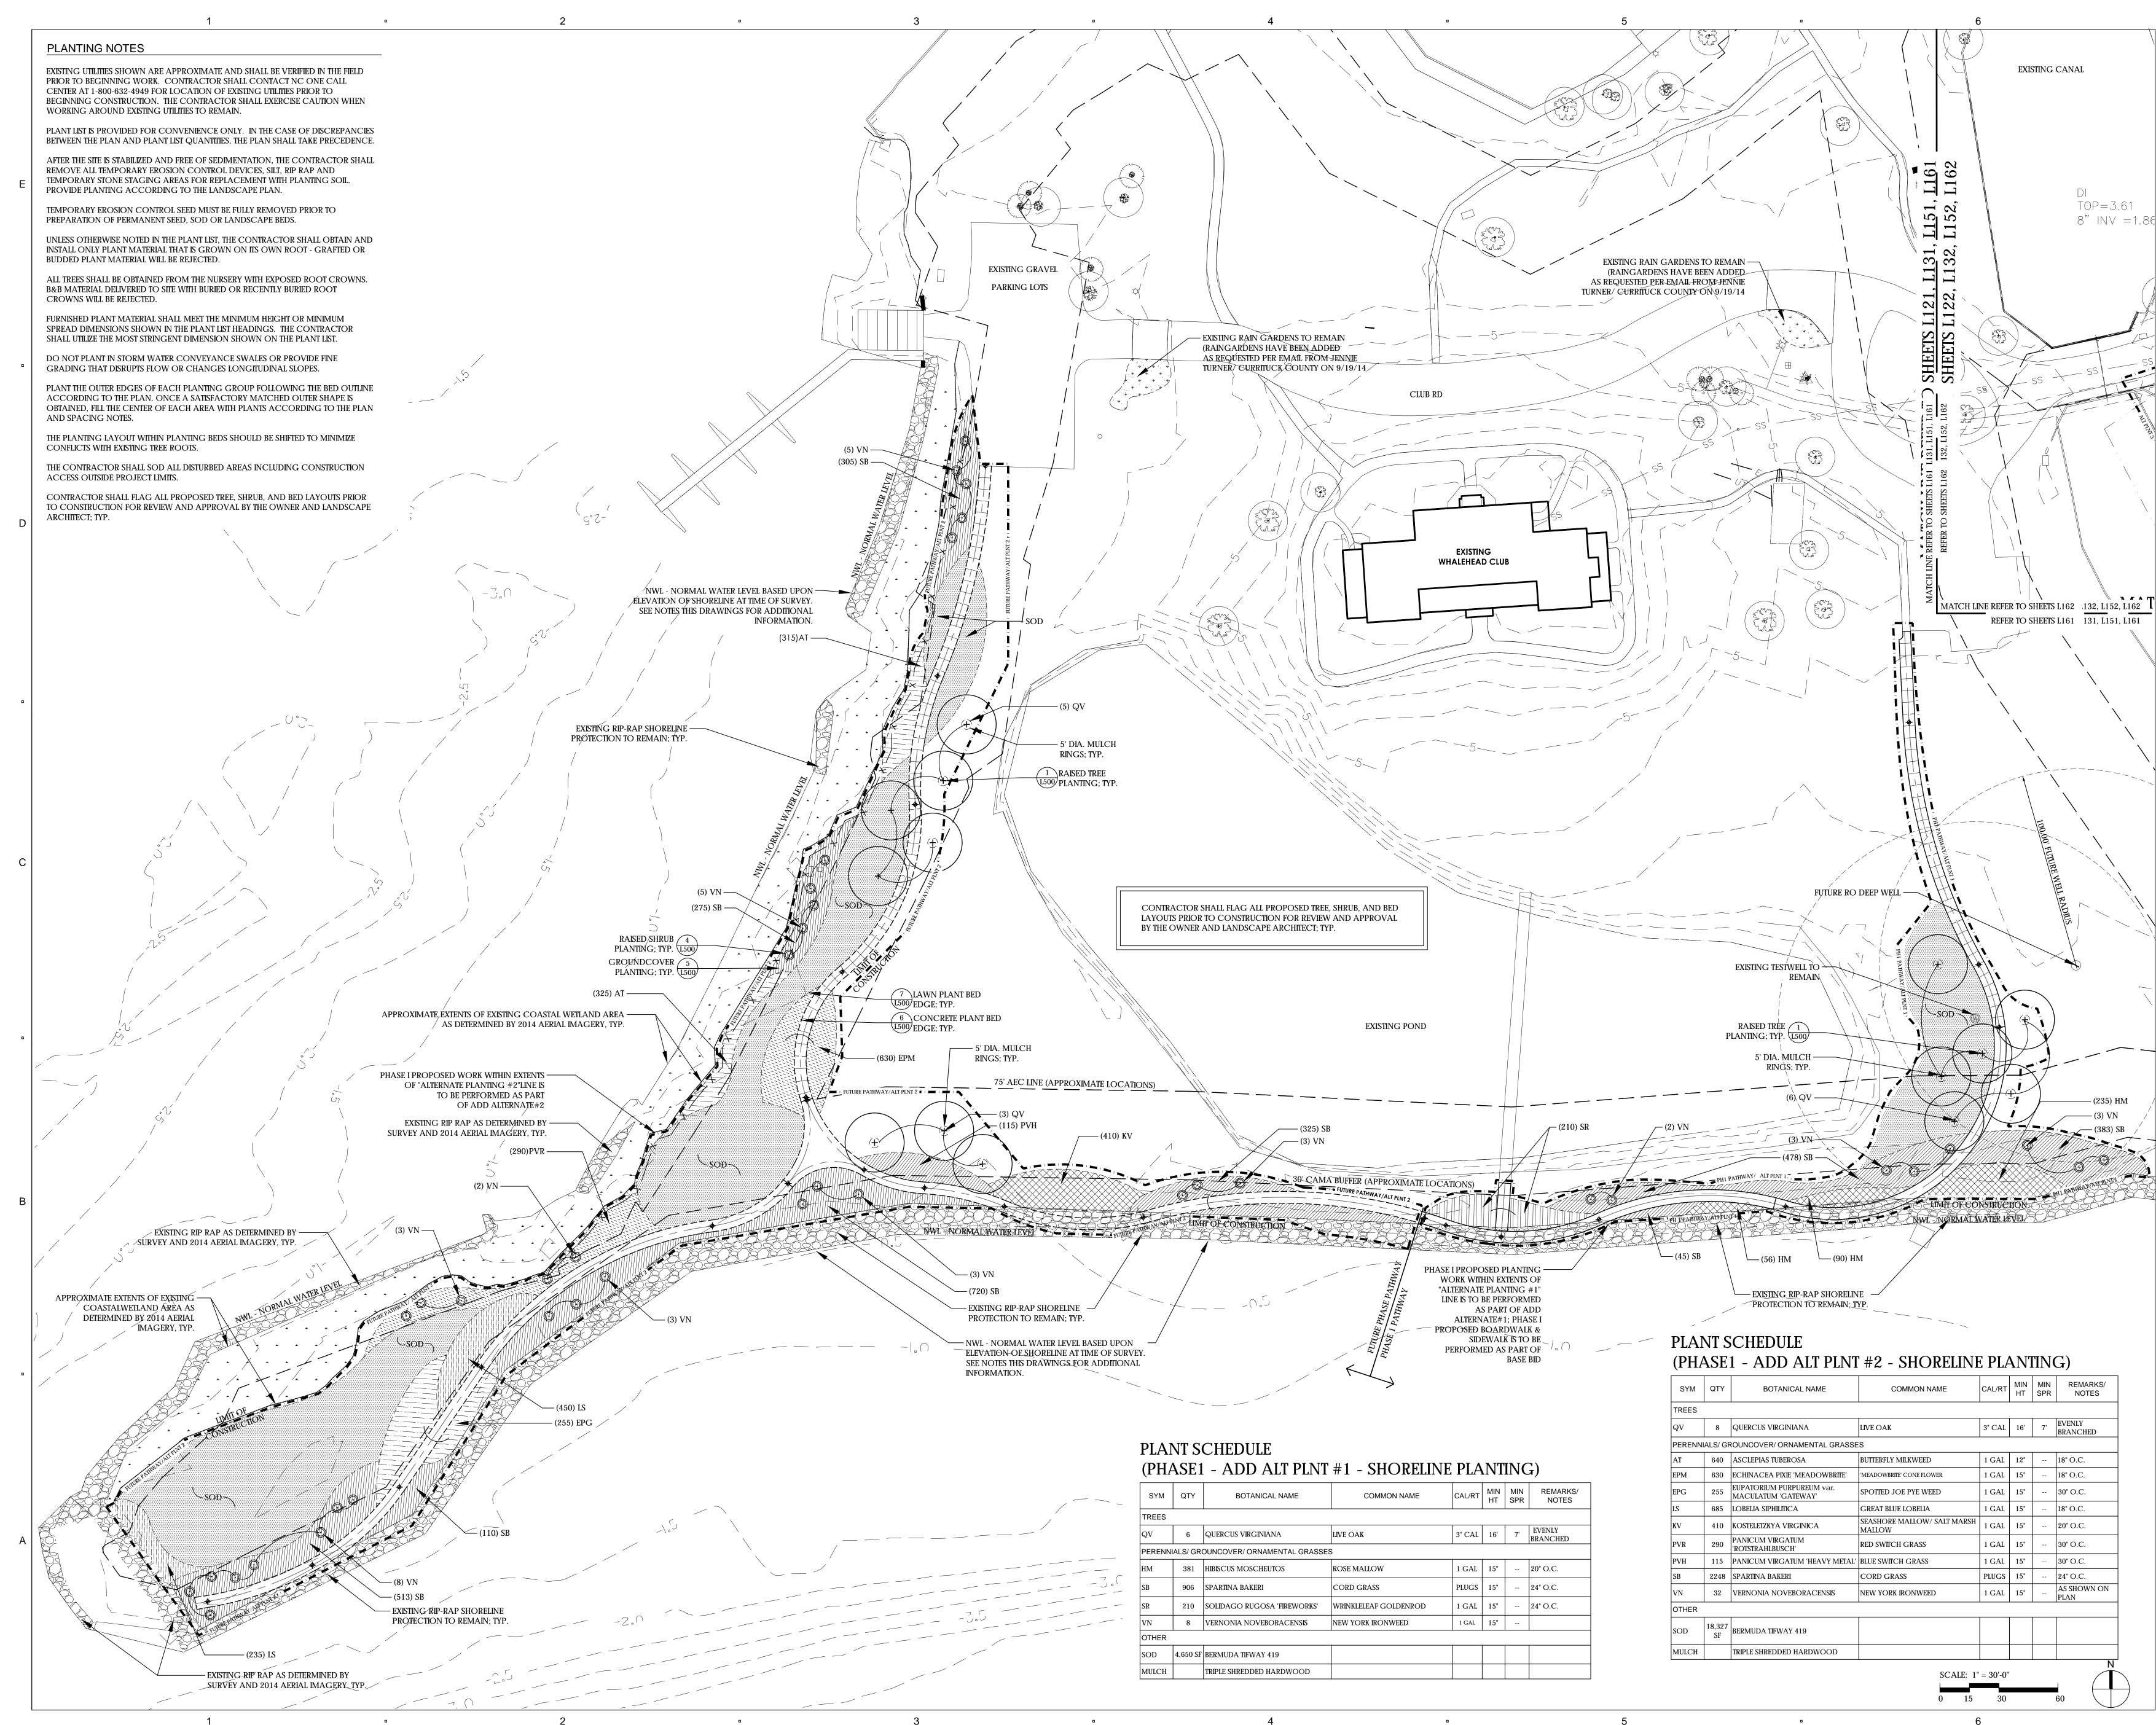


SYM	QTY	BOTANICAL NAME	COMMON NAME	CAL/RT	MIN HT	MIN SPR	REMARKS/ NOTES
TREES	1						•
QV	6	QUERCUS VIRGINIANA	LIVE OAK	3" CAL	16'	7'	EVENLY BRANCHED
PERENN	IALS/ GR	OUNCOVER/ ORNAMENTAL GRASSE	S				
HM	381	HIBISCUS MOSCHEUTOS	ROSE MALLOW	1 GAL	15"		20" O.C.
SB	906	SPARTINA BAKERI	CORD GRASS	PLUGS	15"		24" O.C.
SR	210	SOLIDAGO RUGOSA 'FIREWORKS'	WRINKLELEAF GOLDENROD	1 GAL	15"		24" O.C.
VN	8	VERNONIA NOVEBORACENSIS	NEW YORK IRONWEED	1 GAL	15"		
OTHER	1						•
SOD	4,650 SF	BERMUDA TIFWAY 419					
MULCH		TRIPLE SHREDDED HARDWOOD					

SYM	QTY	BOTANICAL NAME	COMMON NAME	CAL/RT	MIN HT	MIN SPR	REMARKS/ NOTES
TREES							
QV	8	QUERCUS VIRGINIANA	LIVE OAK	3" CAL	16'	7'	EVENLY BRANCHED
PERENN	IALS/ GF	ROUNCOVER/ ORNAMENTAL GRASSE	S				
AT	640	ASCLEPIAS TUBEROSA	BUTTERFLY MILKWEED	1 GAL	12"		18" O.C.
EPM	630	ECHINACEA PIXIE 'MEADOWBRITE'	'MEADOWBRITE' CONE FLOWER	1 GAL	15"		18" O.C.
EPG	255	EUPATORIUM PURPUREUM var. MACULATUM 'GATEWAY'	SPOTTED JOE PYE WEED	1 GAL	15"		30" O.C.
LS	685	LOBELIA SIPHILITICA	GREAT BLUE LOBELIA	1 GAL	15"		18" O.C.
KV	410	KOSTELETZKYA VIRGINICA	SEASHORE MALLOW/ SALT MARSH MALLOW	1 GAL	15"		20" O.C.
PVR	290	PANICUM VIRGATUM 'ROTSTRAHLBUSCH'	RED SWIICH GRASS	1 GAL	15"		30" O.C.
PVH	115	PANICUM VIRGATUM 'HEAVY METAL'	BLUE SWITCH GRASS	1 GAL	15"		30" O.C.
SB	2248	SPARTINA BAKERI	CORD GRASS	PLUGS	15"		24" O.C.
VN	32	VERNONIA NOVEBORACENSIS	NEW YORK IRONWEED	1 GAL	15"		AS SHOWN ON PLAN
OTHER							
SOD	18,327 SF	BERMUDA TIFWAY 419					
		TRIPLE SHREDDED HARDWOOD					



PLANTING PLAN




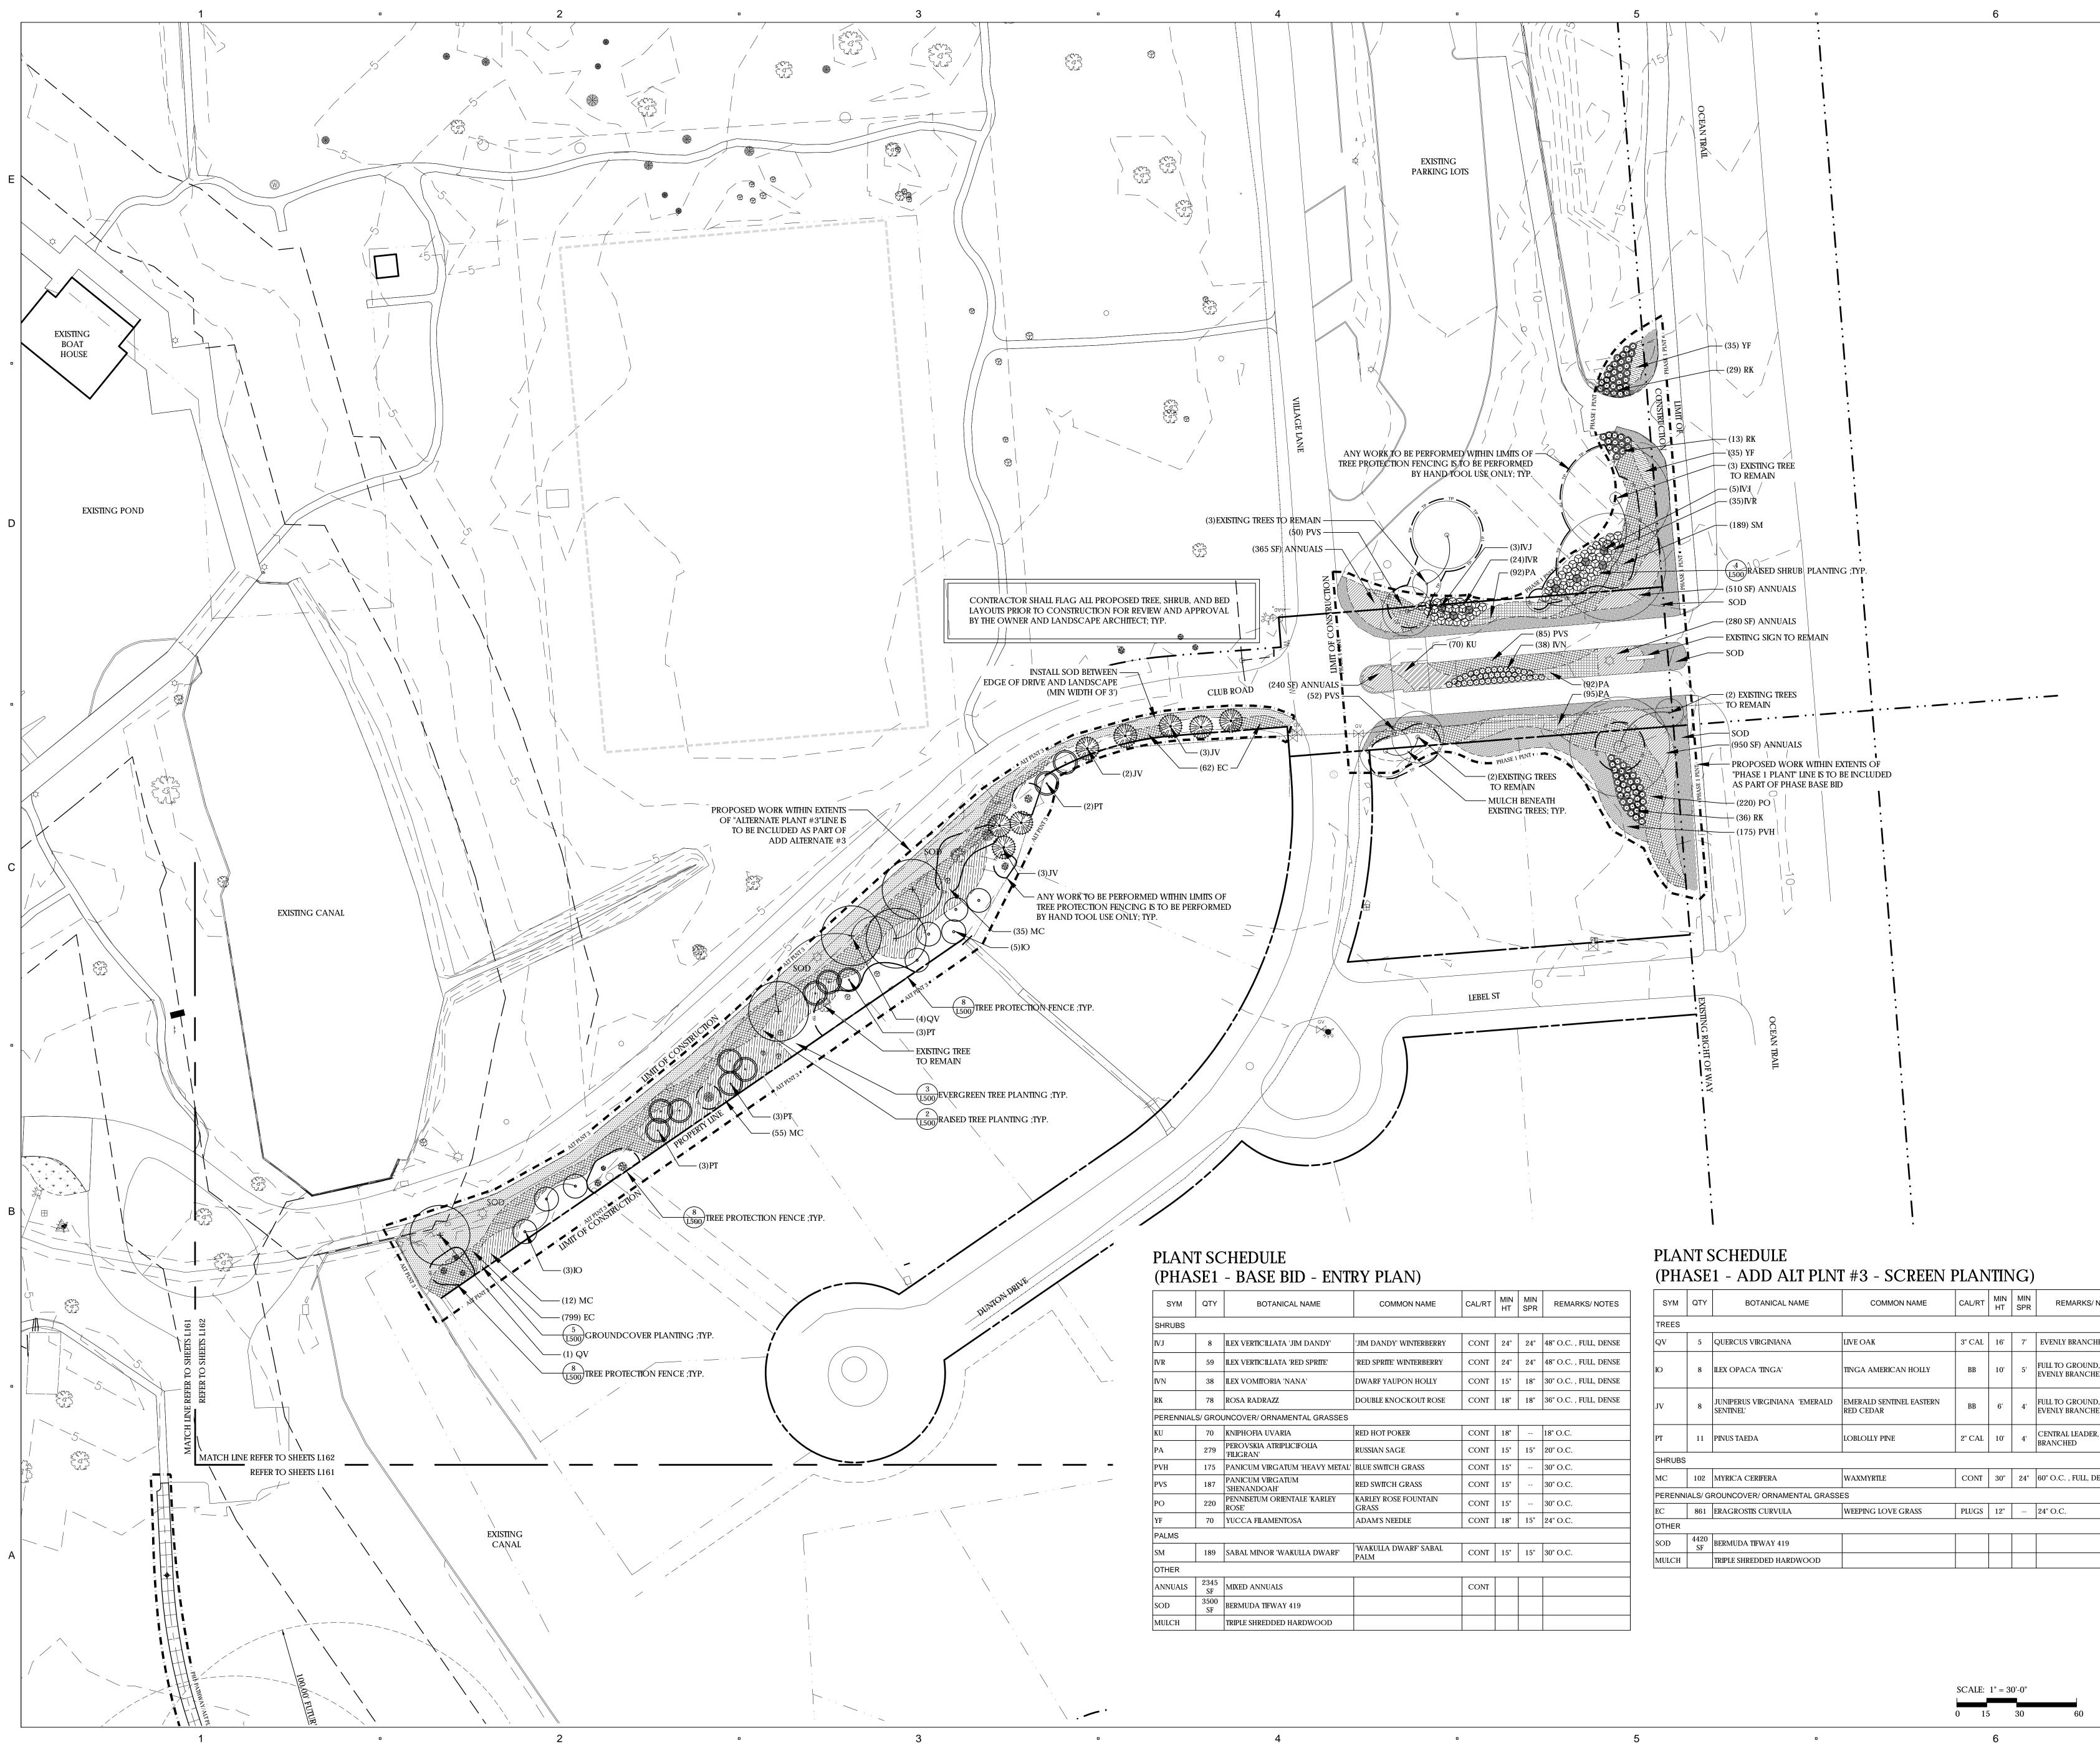

			-	
AME	CAL/RT	MIN HT	MIN SPR	REMARKS/ NOTES
RBERRY	CONT	24"	24"	48" O.C. , FULL, DENSE
BERRY	CONT	24"	24"	48" O.C. , FULL, DENSE
OLLY	CONT	15"	18"	30" O.C. , FULL, DENSE
T ROSE	CONT	18"	18"	36" O.C. , FULL, DENSE
	CONT	18"		18" O.C.
	CONT	15"	15"	20" O.C.
5	CONT	15"		30" O.C.
	CONT	15"		30" O.C.
TAIN	CONT	15"		30" O.C.
	CONT	18"	15"	24" O.C.
SABAL	CONT	15"	15"	30" O.C.
	CONT			


SYM	QTY	BOTANICAL NAME	COMMON NAME	CAL/RT	MIN HT	MIN SPR	REMARKS/ NOTES
TREES							
QV	5	QUERCUS VIRGINIANA	LIVE OAK	3" CAL	16'	7'	EVENLY BRANCHED
Ю	8	ILEX OPACA 'TINGA'	TINGA AMERICAN HOLLY	BB	10'	5'	FULL TO GROUND, DENSE, EVENLY BRANCHED
JV	8	JUNIPERUS VIRGINIANA 'EMERALD SENTINEL'	EMERALD SENTINEL EASTERN RED CEDAR	BB	6'	4'	FULL TO GROUND, DENSE, EVENLY BRANCHED
PT	11	PINUS TAEDA	LOBLOLLY PINE	2" CAL	10'	4'	CENTRAL LEADER, EVENLY BRANCHED
SHRUBS							
МС	102	MYRICA CERIFERA	WAXMYRTLE	CONT	30"	24"	60" O.C. , FULL, DENSE
PERENNI	ALS/ G	ROUNCOVER/ ORNAMENTAL GRASSI	ËS				
EC	861	ERAGROSTIS CURVULA	WEEPING LOVE GRASS	PLUGS	12"		24" O.C.
OTHER							
SOD	4420 SF	BERMUDA TIFWAY 419					
MULCH		TRIPLE SHREDDED HARDWOOD					



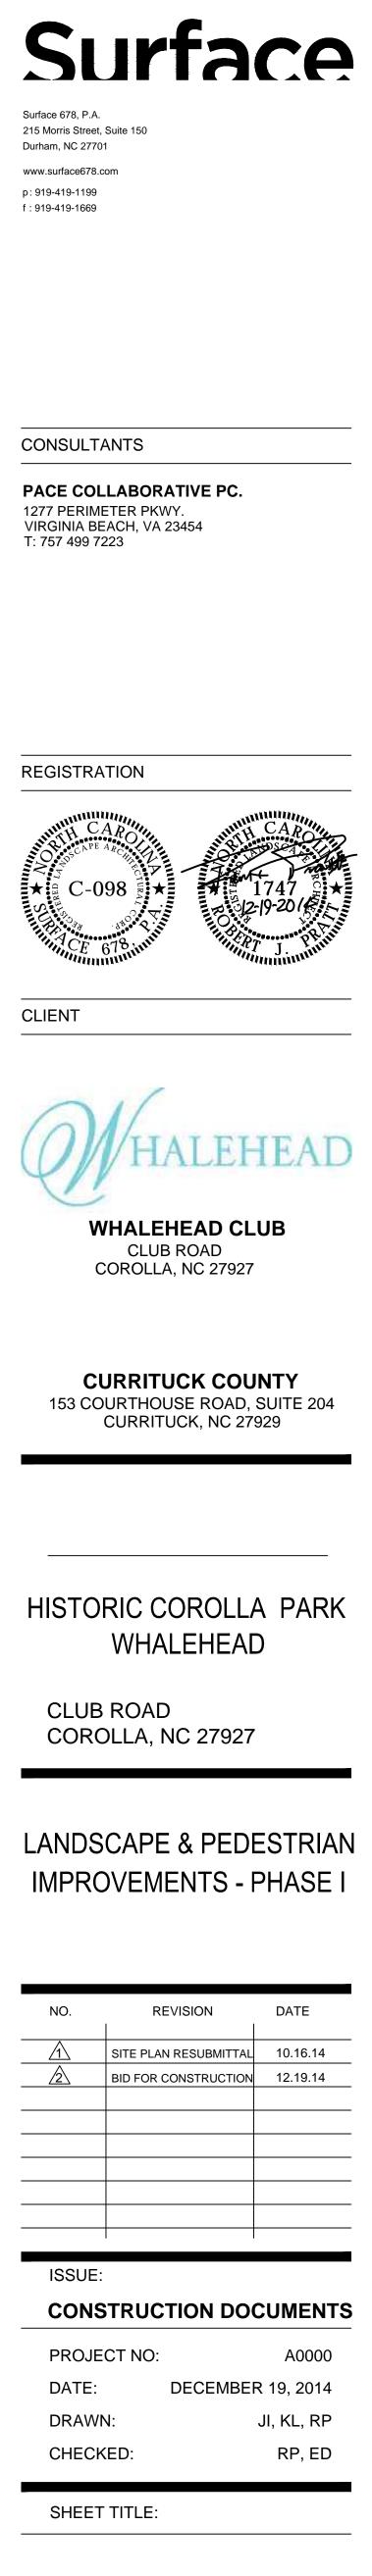

PLANTING PLAN



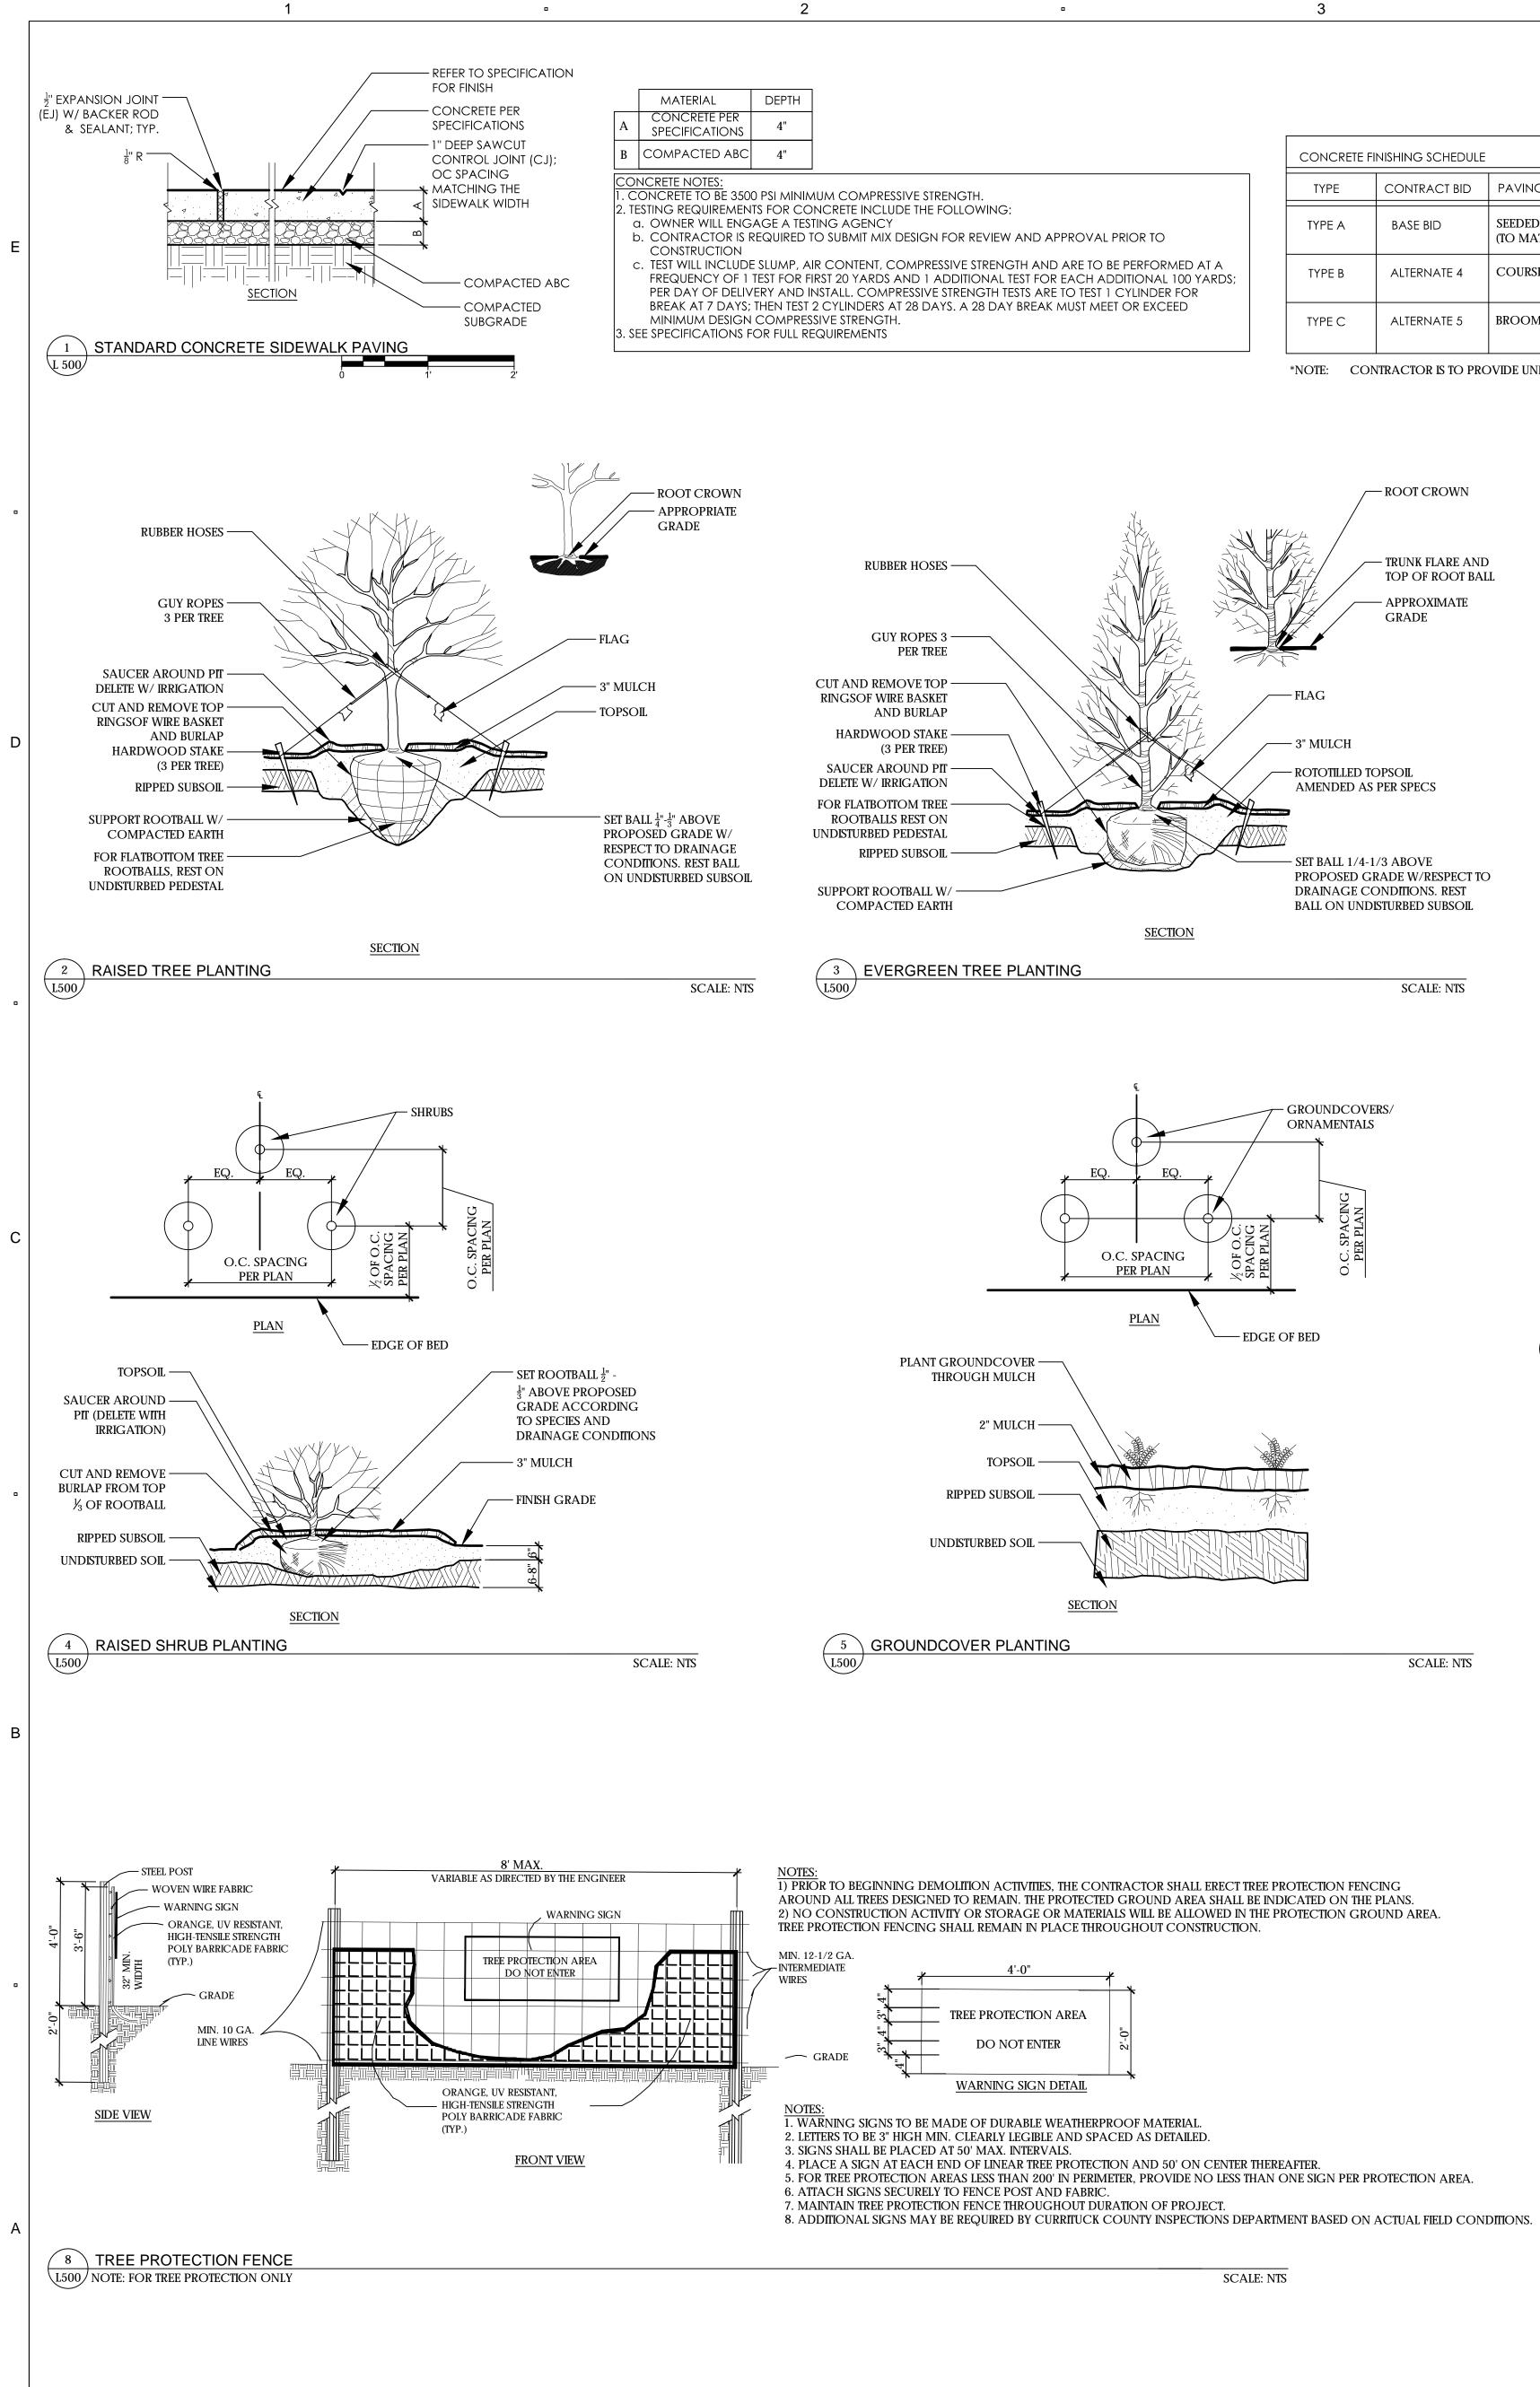

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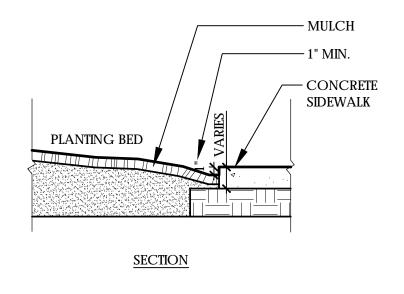
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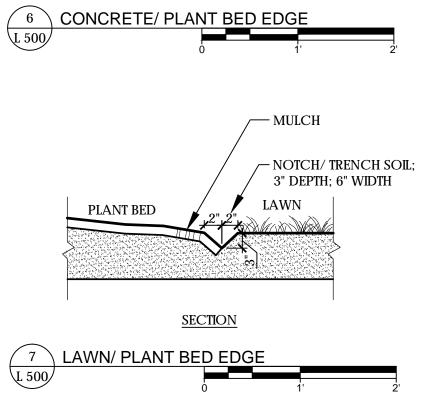
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REVIEW AND APPROVAL PRIOR TO	
STRENGTH AND ARE TO BE PERFORMED ONAL TEST FOR EACH ADDITIONAL 100 NGTH TESTS ARE TO TEST 1 CYLINDER FOR 28 DAY BREAK MUST MEET OR EXCEED	Y


INISHING SCHEDULE	:			
CONTRACT BID	PAVING DESCRIPTION	COLOR	FINISH	FI
BASE BID	SEEDED SHELL AGGREGATE (TO MATCH EXISTING)	STANDARD GRAY	ROLLED & SEEDED	ST. SH
ALTERNATE 4	COURSE ROCK SALT FINISH	STANDARD GRAY	SALT OR SALT ROLLED	ST. SA
ALTERNATE 5	BROOM SWEPT FINISH	STANDARD GRAY	MEDIUM BROOM	ST.
	CONTRACT BID BASE BID ALTERNATE 4	BASE BID       SEEDED SHELL AGGREGATE (TO MATCH EXISTING)         ALTERNATE 4       COURSE ROCK SALT FINISH	CONTRACT BID       PAVING DESCRIPTION       COLOR         BASE BID       SEEDED SHELL AGGREGATE (TO MATCH EXISTING)       STANDARD GRAY         ALTERNATE 4       COURSE ROCK SALT FINISH       STANDARD GRAY	CONTRACT BID       PAVING DESCRIPTION       COLOR       FINISH         BASE BID       SEEDED SHELL AGGREGATE (TO MATCH EXISTING)       STANDARD GRAY       ROLLED & SEEDED         ALTERNATE 4       COURSE ROCK SALT FINISH       STANDARD GRAY       SALT OR SALT ROLLED

\*NOTE: CONTRACTOR IS TO PROVIDE UNIT PRICES PER CONTRACT FOR BOTH BASE BID AND ALTERNATE CONCRETE TYPES





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TOP AND BOTTOM ·

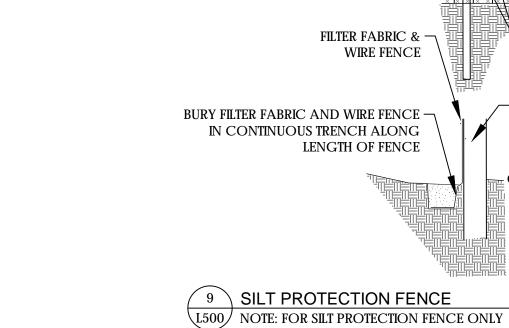10 GAUGE

WIRE STRAND SHALL BE

ISH
NDARD AGGREGATE W/ BROKEN LLS SEEDED ON SURFACE
NDARD AGGREGATE W/ ROCK T SEEDED ON SURFACE
NDARD AGGREGATE


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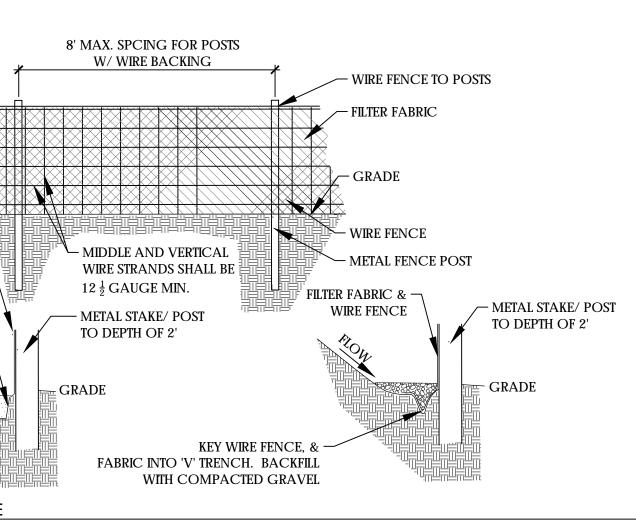
(1A) CONCRETE TYPE A / SEEDED SHELL AGGREGATE



1B CONCRETE TYPE B / ROCK SALT



(1C) CONCRETE TYPE C / BROOM SWEPT

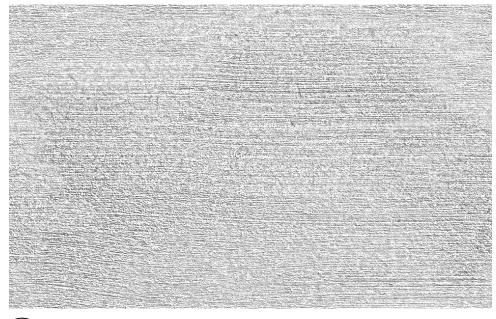

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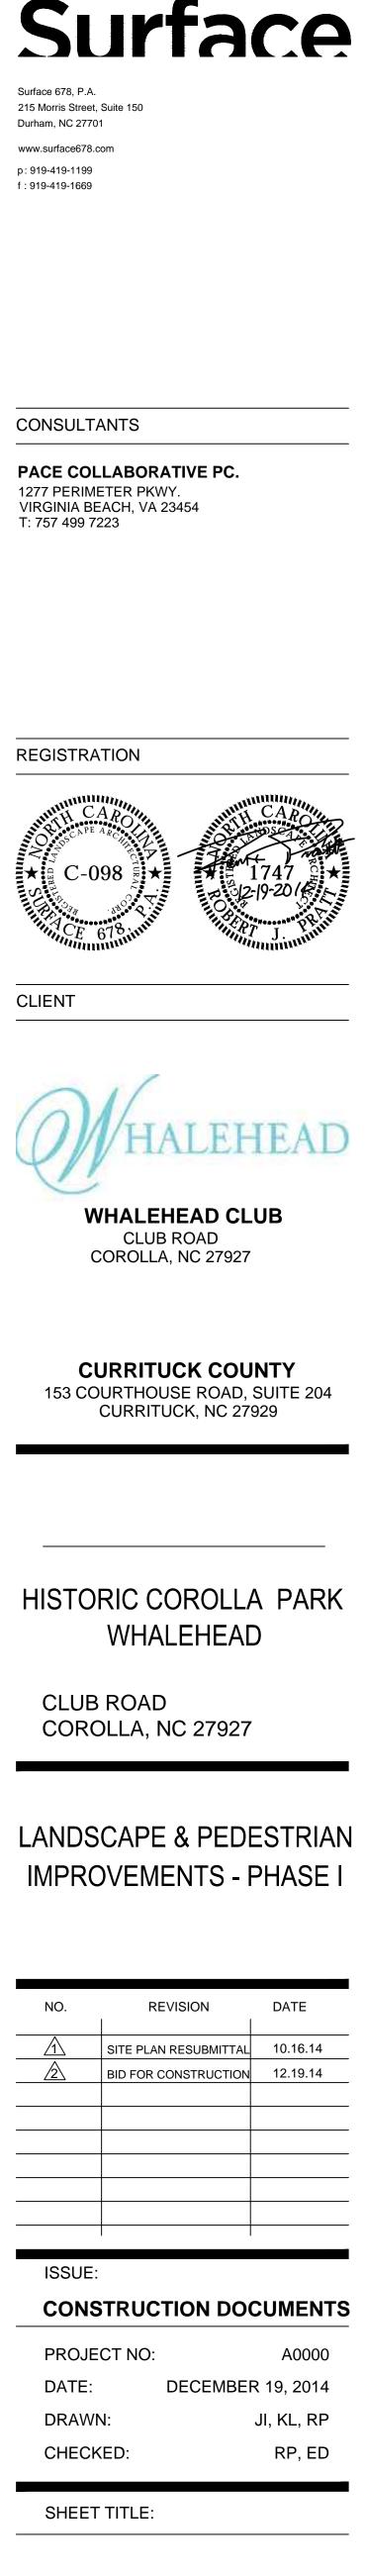
1. USE A WIRE MINIMUM OF 32" IN HEIGHT AND WITH A MINIMUM OF 6 LINE WIRES WITH 12" SPACING. 2. USE FILTER FABRIC WITH A MINIMUM OF 36" HEIGHT AND FASTEN ADEQUATELY TO WIRE. 3. USE 5'-0" SELF-FASTENER ANGLE STEEL POSTS.

MAINTENANCE NOTES: 1. USE SILT FENCE ONLY WHEN DRAINAGE AREA DOES NOT EXCEED  $\frac{1}{4}$ ACRE AND NEVER IN AREAS OF CONCENTRATED FLOW. 2. REMOVE SEDIMENT DEPOSITED AS NEEDED TO PROVIDE STORAGE VOLUME FOR THE NEXT RAIN AND TO REMOVE PRESSURE ON THE SILT FENCE.

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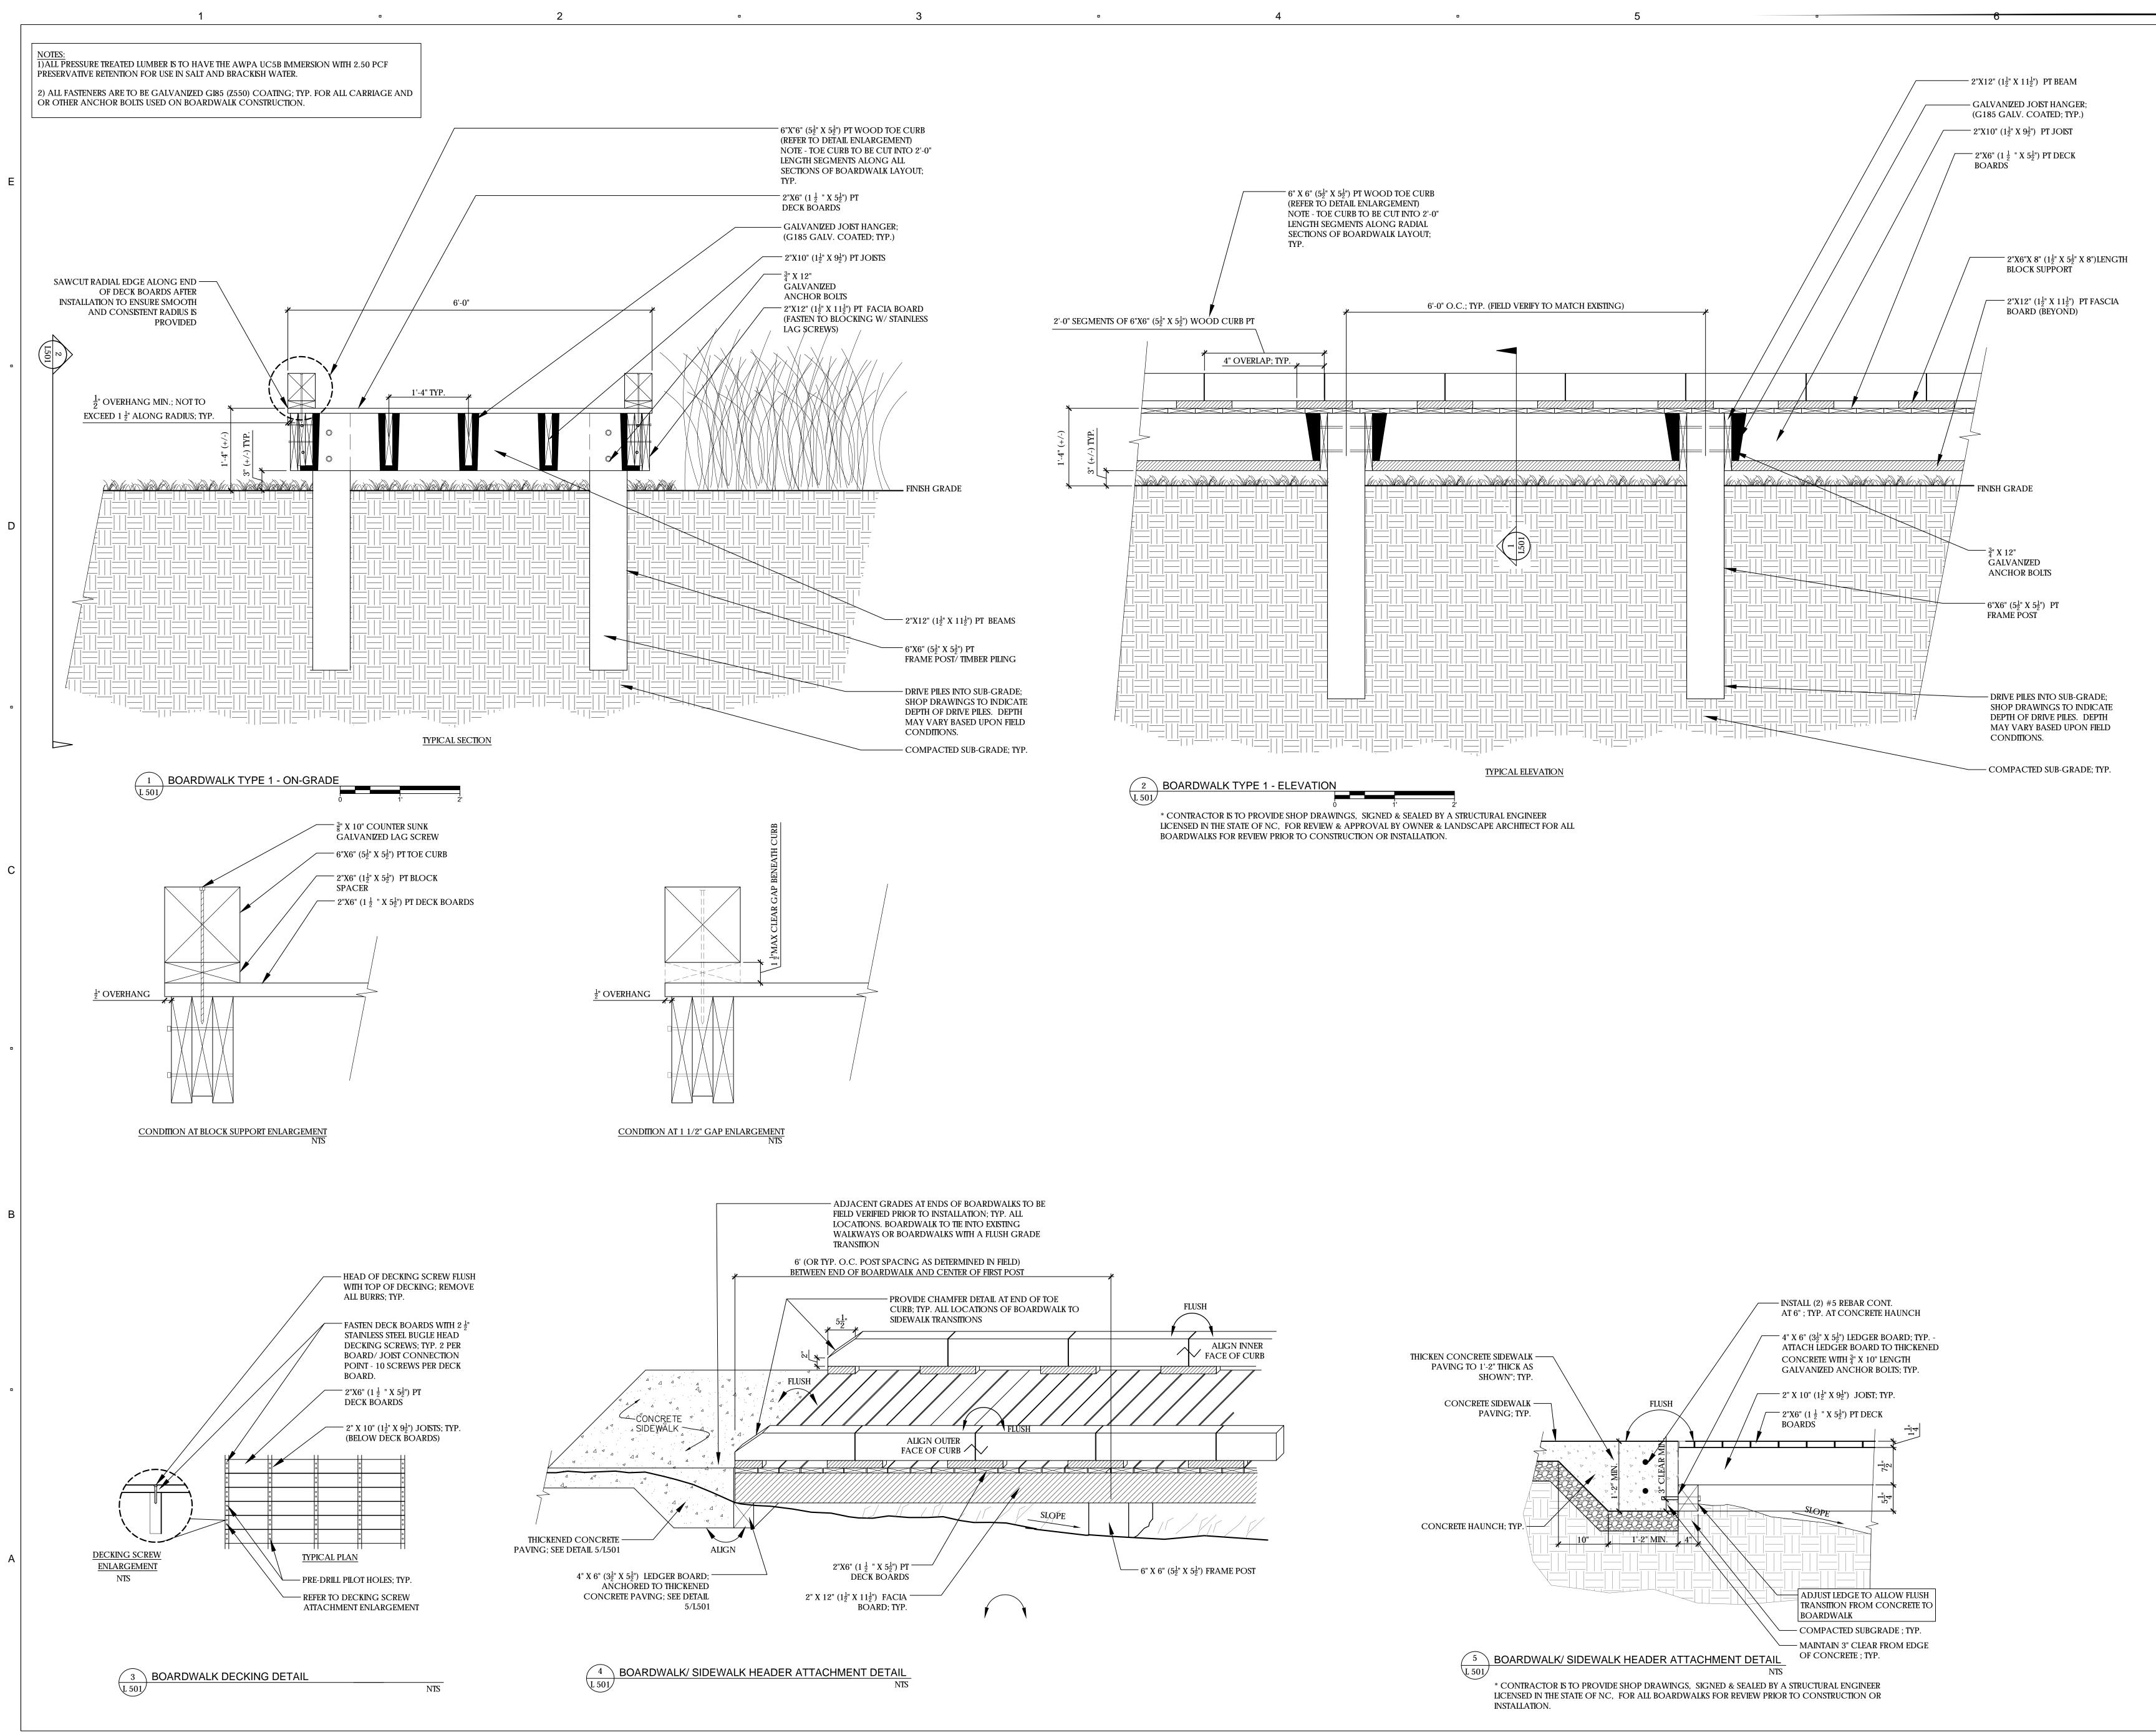
SCALE: NTS

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DETAILS

L500



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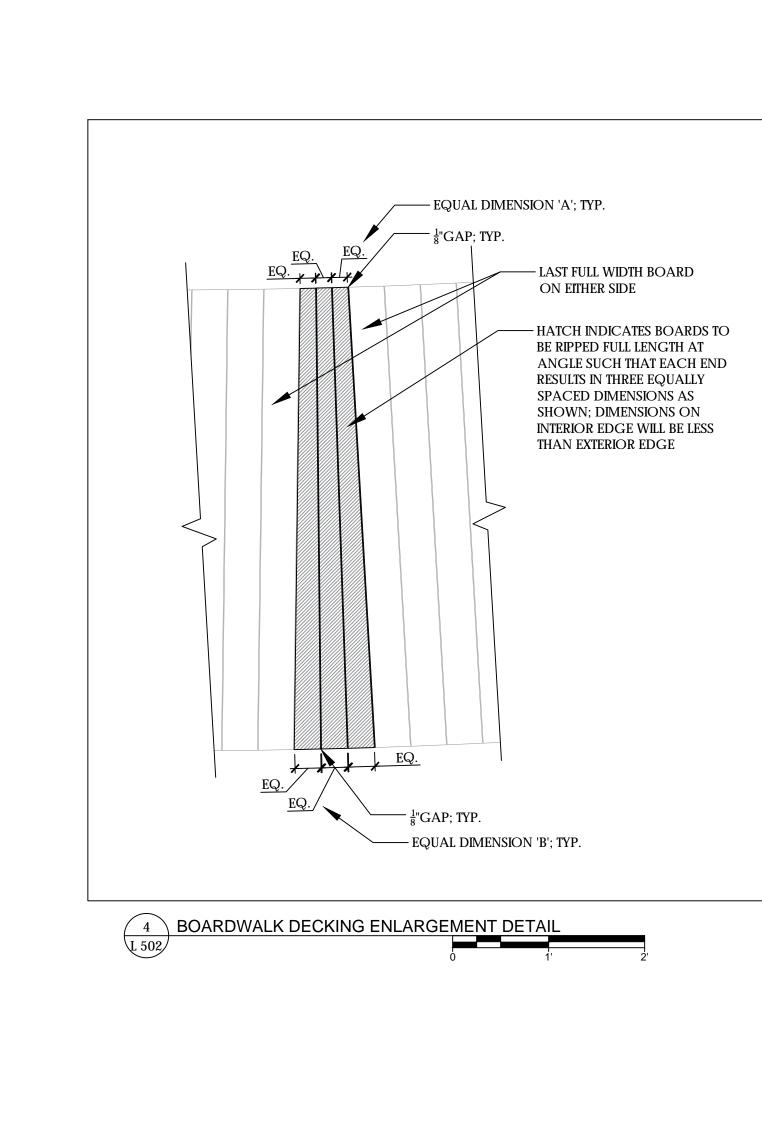
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L501

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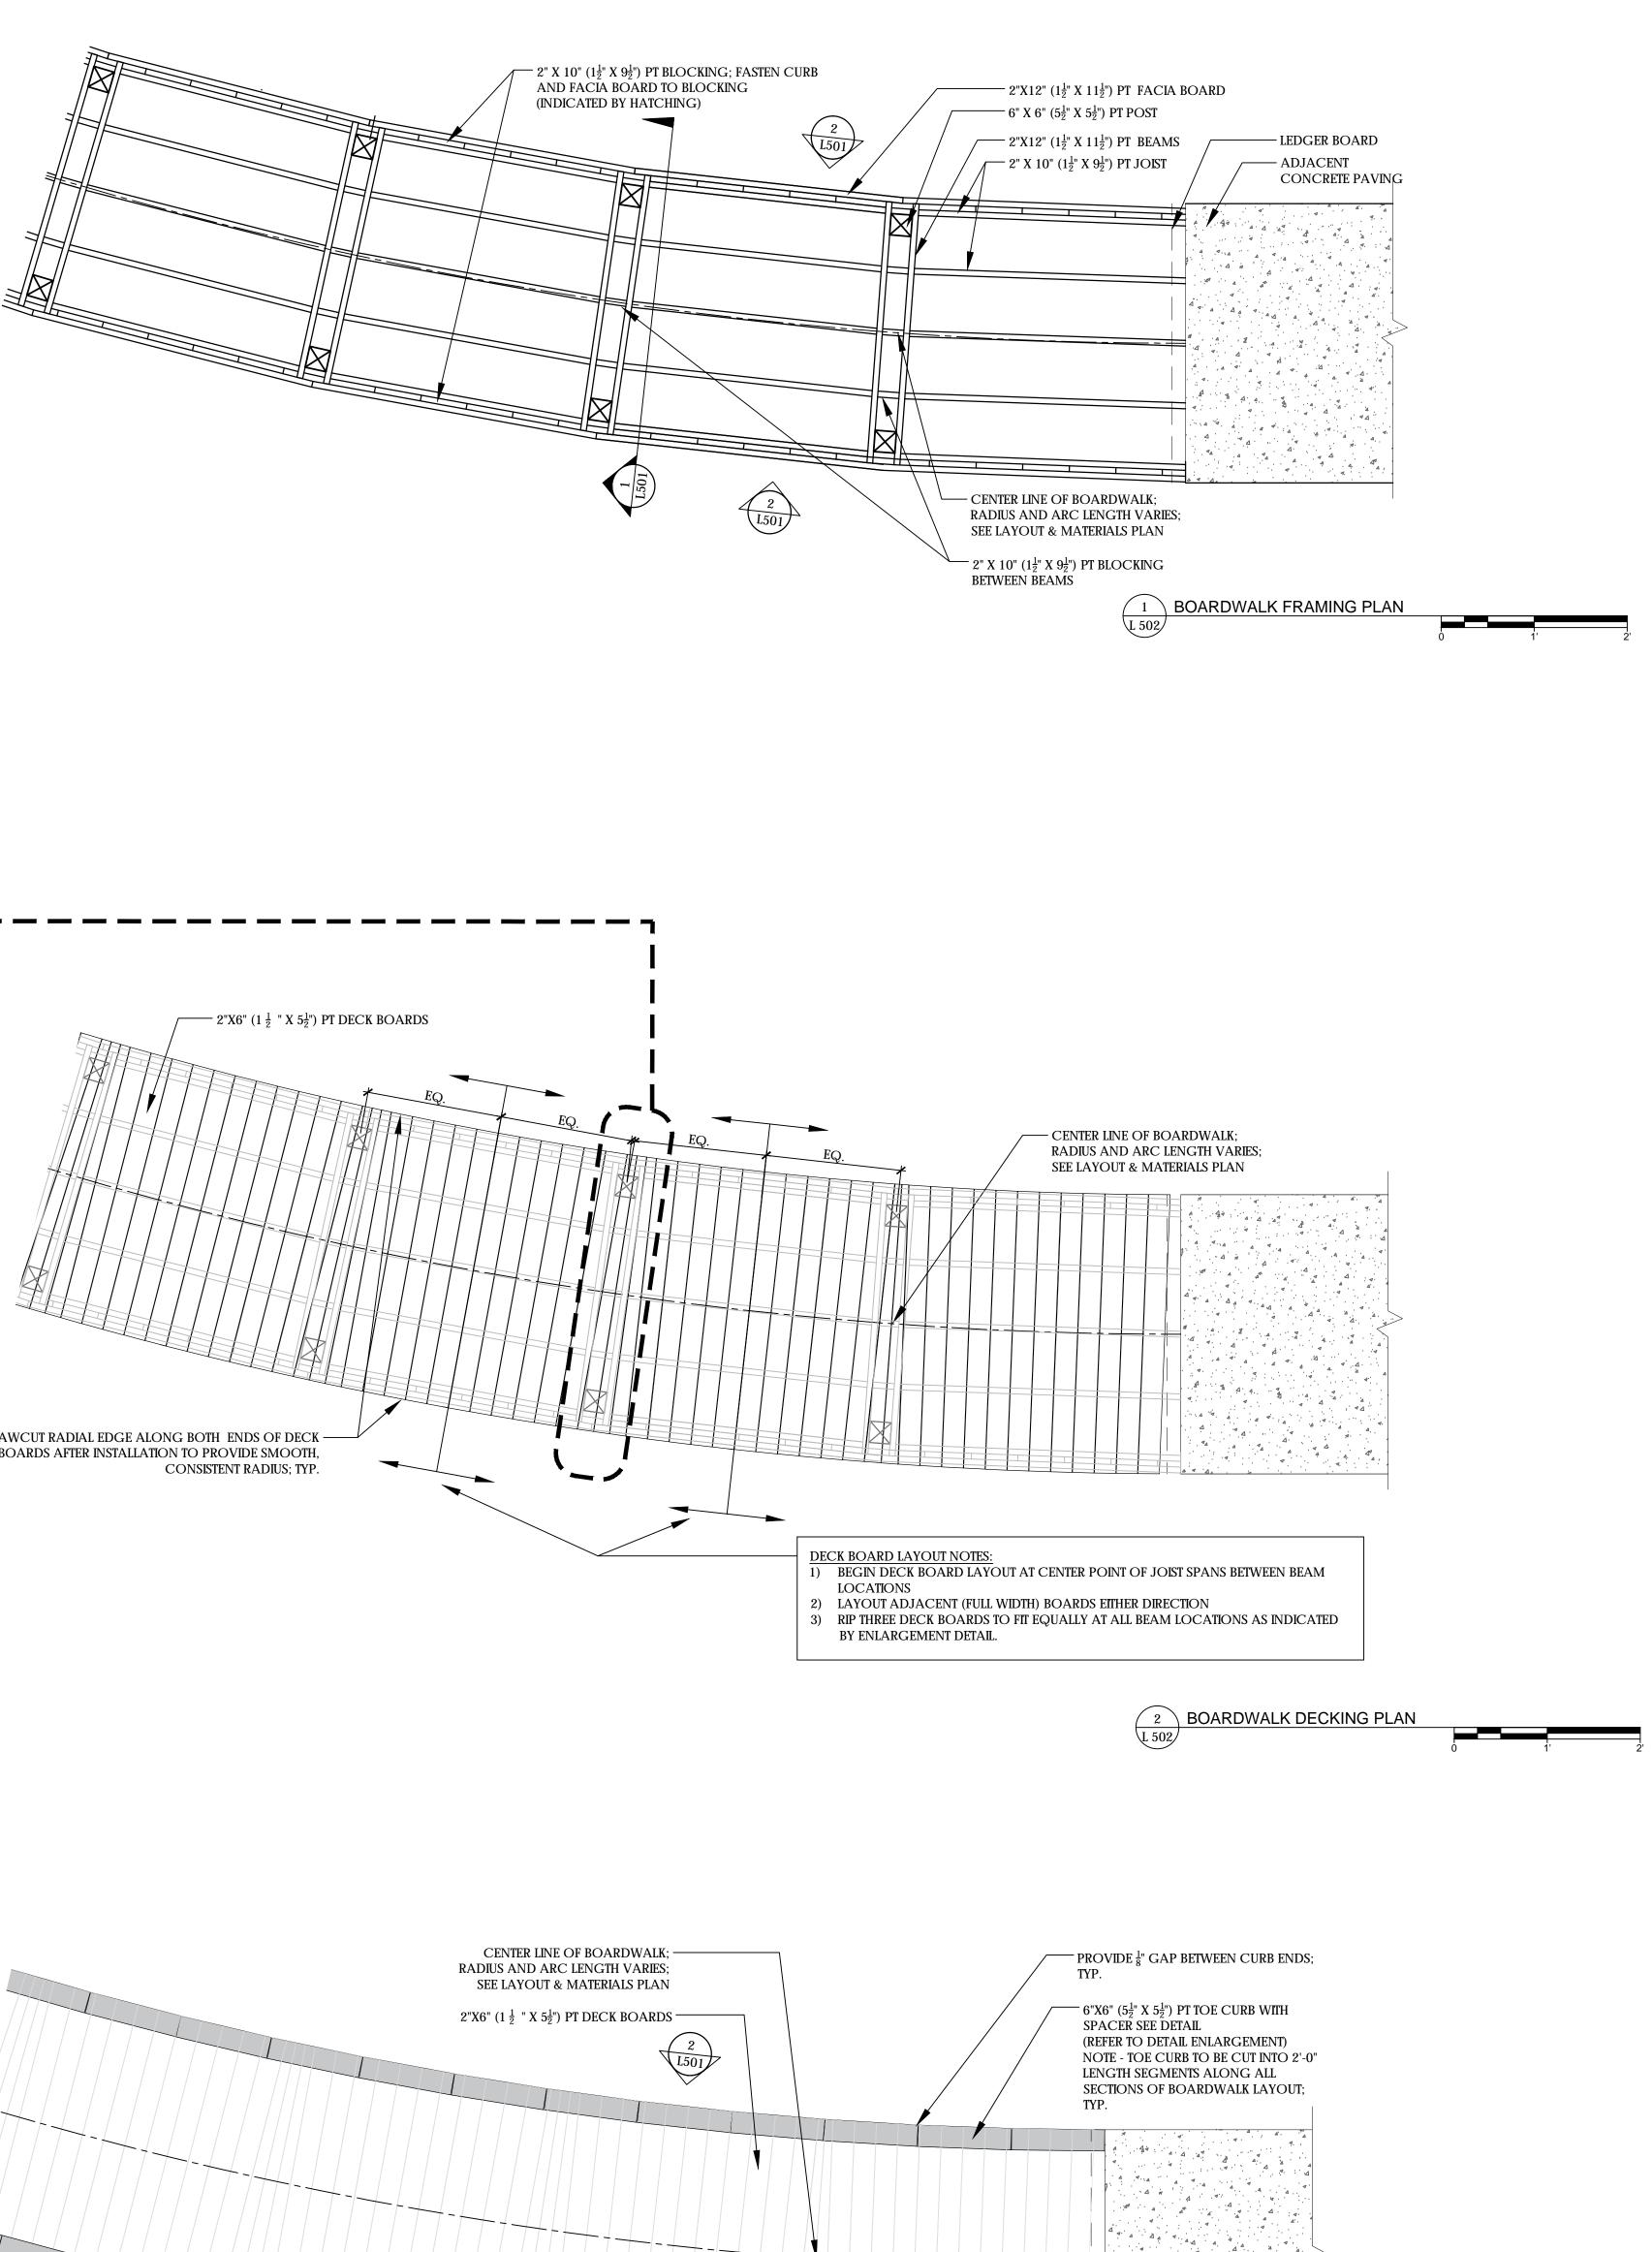
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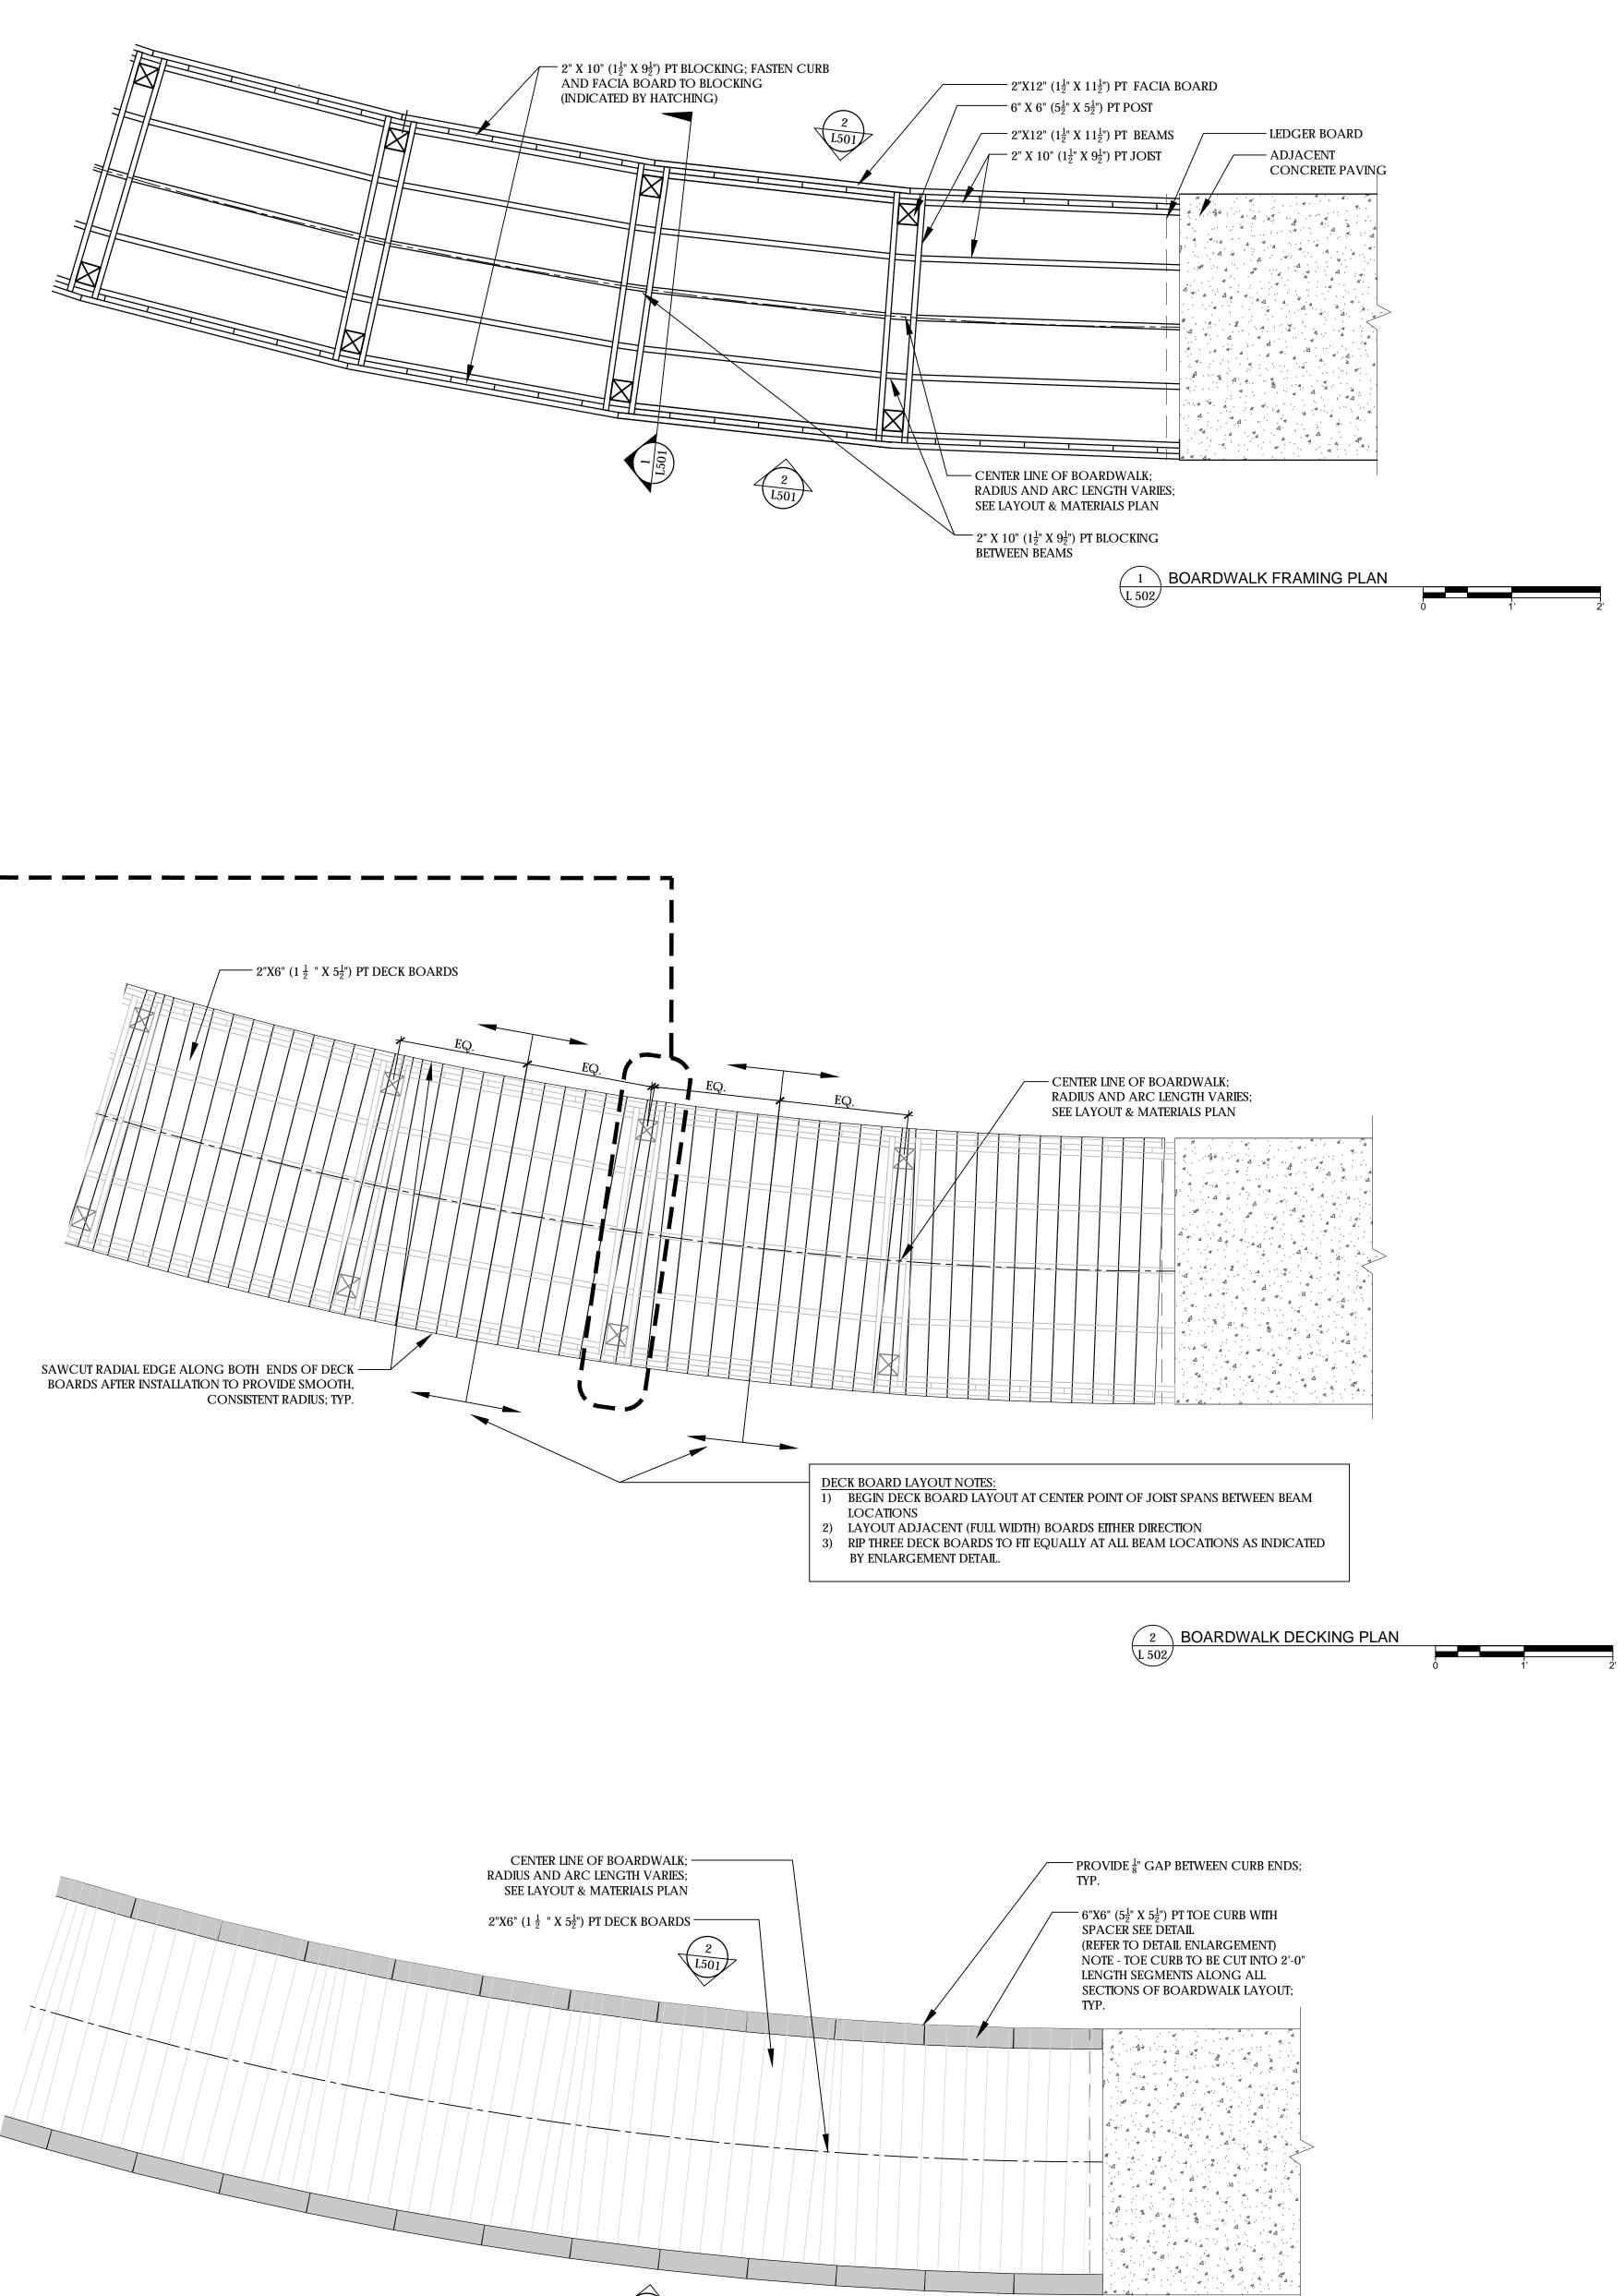
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2 L501

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3 BOARDWALK TOE CURB LAYOUT PLAN

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# ELECTRICAL SPECIFICATIONS

SECTION 16010 – GENERAL PROVISIONS

PART 1 – GENERAL

1.1 Codes and standards — the latest effective publications of all applicable standards, codes, etc., as they apply, form part of these specifications as if were written fully herein and constitute minimum requirements. The following will be referred to throughout in abbreviated forms.

- A. National Electrical Code, (NFPA 70) (NEC).
- B. Institute of Electrical and Electronic Engineers (IEEE).
- C. National Electrical Manufacturer's Association (NEMA).
- D. American National Standards Institute (ANSI).
- E. Applicable local codes.
- F. Underwriter's Laboratories, Inc. (UL).
- G. National Fire Protection Association (NFPA).
- H. North Carolina Building Code

1.2 Scope of work – provide all work required for this division including all labor, materials, equipment, appurtenances and services to provide complete electrical systems as shown on the drawings and specified in this division of the specifications. The word "provide" shall mean "furnish and install complete and ready for use".

1.3 The Contractor shall visit the site prior to bid to determine the extent of the work. Lack of knowledge of existing conditions will not be considered a basis for change orders.

1.4 Drawings and specifications – the drawings are diagrammatic and indicate the general extent, character and arrangement of equipment, fixtures and conduit and wiring systems. It is the intention of these specifications and drawings to fully cover all work and materials for a complete, first class electrical installation, and any devices such as pull boxes and disconnect switches, usually employed in this class of work, though not specifically mentioned or shown on the drawings or in this specification, but which may be necessary for the satisfactory completion of the work, shall be furnished and installed by the Contractor as a part of his total work under this Division. Consult the specifications and drawings of all other trades and perform all electrical work required therein. Cooperate with all other Contractors or Subcontractors to furnish complete workable systems.

1.5 During construction, keep an accurate record of all deviations between the work as shown on the contract drawings and that which is actually installed on a set of blue line prints of the electrical drawings, and note changes thereon with red marks, in a neat and accurate manner. When all revisions have been shown on these prints to indicate the work as finally installed, the prints shall be delivered to the Owner, before final payment.

1.6 Permits, inspection and tests – the right is reserved to inspect and test any portion of the installation/equipment during the progress of its erection. This Contractor shall test all wiring for continuity and grounds before connecting any fixtures or devices. This Contractor shall test the entire system when the work is finally completed to insure that all portions are free from short circuits and grounds.

1.7 Secure and pay for all required permits and inspections. Inspection certificates from local authorities having jurisdiction shall be delivered to the Owner before final payment.

1.8 Submittals – submit shop drawings, product data and samples within thirty (30) days of award of contract and in accordance with the general conditions and supplementary conditions. Submittals are required for all items provided under this specification. Review of submittals by the Engineer and any associated action taken by the Engineer does not relieve the Contractor of any requirements set forth by the contract documents.

PART 2 – PRODUCTS

2.1 Manufacturing standards — materials shall be new and approved and labeled by UL wherever standards have been established by that agency. Defective equipment or equipment damaged in the course of installation or test shall be replaced or repaired in a manner meeting the approval of the Owner. All items of the same type and rating shall be identical.

2.2 Trade names – unless specifically identified otherwise, manufacturers' names and catalog numbers indicated herein and on the drawings are not intended to be proprietary designations. They are to indicate general type and quality of materials and equipment required. Equipment and materials by other manufacturers which in the opinion of the Engineer are of equal quality and which will produce the same results will be considered acceptable.

2.3 Obtain approved shop drawings showing wiring diagrams, connection diagrams, roughing—in and hookup details, from other involved Contractors for all equipment and comply therewith.

2.4 Grounding – the entire electrical system, including equipment frames, conduit, switches, controllers, wireways, neutral conductors, and all other such equipment shall be permanently and effectively grounded in accordance with the NEC. Provide a separate ground conductor in all branch circuit conduits sized in accordance with the NEC.

2.5 Schedule of work — the schedule of the electrical work shall be arranged to suit the progress of work by the other trades and shall in no way retard progress of construction of the project.

2.6 Storage and materials – space will be assigned to the Contractor by the Owner for the storage of materials. This Contractor will be responsible for the protection and safekeeping of materials, tools, and equipment. All materials and equipment shall be kept in its assigned place until the time of its installation. Excess materials, dirt and refuse shall be promptly removed from the work site.

2.7 Coordination — cooperate and coordinate efforts with all Contractors on the project.

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2.8 Guarantee of work – Contractor guarantees by his acceptance of the contract that all work installed is free from any and all defects in workmanship and/or materials, and that the apparatus will develop capacities and characteristics specified, and that if, during the period of one year or as otherwise specified, from date of certificate of completion and acceptance of the work any such defects in workmanship, material or performance appear, he will, without cost to the Owner, remedy such defects within a reasonable time to be specified in notice. In default thereof, the Owner may have such work done and charge cost to Contractor. Equipment guarantees from date of "start-up" will not be recognized.

3

SECTION 16210 - RACEWAY, FITTINGS AND BOXES

A. Raceways — conduit shall be hot—dipped, zinc coated or sherardized rigid steel (RS), intermediate metal conduit (IMC), or Schedule 40 PolyVinyl Chloride (PVC).

B. Flexible conduit shall be galvanized, continuous spiral, single strip type. Flexible conduit shall be covered with PVC jacket in wet or damp locations. Provide suitable fittings with ground connector.

C. Fittings — all conduit entering or leaving outlet, junction or pull boxes, and cabinets and all conduit stubs shall have bushings. Provide insulating bushie

D. ngs where required by NEC.

1. Fittings for RS and IMC shall be threaded type.

D. Fittings for PVC shall be PVC, primed and glued.

E. Conduit run outside of building shall be buried a minimum of 24" below finished grade.

F. Conduit run underground may be polyvinyl chloride (PVC) or RS or IMC conduit protected with 2 coats of bitumastic paint. Convert PVC to RS or IMC before rising out of soil.

SECTION 16220 - CONDUCTORS

A. Conductors and insulation – wire and cable shall be soft drawn, annealed copper with 600 volt color coded insulation. Minimum wire size shall be #12 awg. Insulation for branch circuits and feeders shall be type THHN-2-THWN-2 or XHHW-2. Conductors No. 10 AWG and smaller diameter shall be solid.

B. Provide a separate ground conductor in all raceways sized in accordance with the NEC.

C. Joints and terminations — for conductors #12 and #10 all fixture and branch circuits joints in junction and outlet boxes shall be made with UL listed pressure type connectors rated at 600 volts and 105 degrees C. Connectors shall be Ideal Industries "Wing-Nut" or Buchannan "B-Cap", 3M "Scotch-Lok" connectors or equal.

SECTION 16230 - WIRING DEVICES

A. Photocell switch shall be hermetically sealed cadmium-sulfide cell with single pole double-throw (SPDT) contacts for control of mechanically held contactors rated 1000 watts and 120 volts.
Provide switch in a high-impact-resistant noncorroding and nonconductive molded plastic housing with a locking-type receptacle.
A time delay shall prevent accidental switching from transient light sources. Provide a directional lens in front of the cell to prevent fixed light sources from creating a turnoff condition. Aim switch according to manufacturer's recommendations.

SECTION 16311 - CIRCUIT BREAKERS

A. Circuit breakers shall be provided as indicated on drawings and be fully compatible with panelboards. Circuit breakers shall conform to latest UL and NEMA standards and shall bear UL labels.

B. Circuit breakers shall be single, double pole, or three pole thermalmagnetic quick-make, quick-break trip-free on overload or short circuit alternating current circuit breakers with trip ratings and frame size as shown on the drawings. Branch circuit breakers shall provide inverse time delayed tripping on overloads and instantaneous tripping on short circuits. Trip indication shall be clearly shown by the breaker handle taking position between ON and OFF when the breaker is tripped. Double and three-pole breakers shall be common trip type. Sub-feed breakers are not acceptable.

C. Circuit breakers shall be fully rated for the available fault current, series ratings are not acceptable, unless stated otherwise on drawings.

D. Circuit breakers shall be installed in conformance with panelboard manufacturer's recommendations.

### GENERAL ELECTRICAL NOTES

**GENERAL:** UNLESS SPECIFICALLY INDICATED OTHERWISE, ALL WORK SHOWN ON ELECTRICAL DRAWINGS IS NEW WORK TO BE PROVIDED UNDER THIS CONTRACT.

**COORDINATION:** COORDINATE AND COOPERATE WITH ALL TRADES ON THE PROJECT. THE CONTRACTOR SHALL REVIEW ALL CONTRACT DOCUMENTS INCLUDING CIVIL AND LANDSCAPE DRAWINGS AND SPECIFICATIONS. CONTRACTOR SHALL COORDINATE AND ADJUST ACCORDINGLY AS DIRECTED BY THE ENGINEER.

**INSPECTIONS:** ARRANGE ALL NECESSARY INSPECTIONS. DELIVER ALL REQUIRED INSPECTION CERTIFICATES TO THE OWNER.

**J-BOX LABELING:** LABEL ALL JUNCTION BOXES WITH PERMANENT MARKER IDENTIFYING CIRCUIT NUMBER AND PANELBOARD OF CIRCUITS WITHIN.

**PANEL DIRECTORY:** PROVIDE TYPEWRITTEN PANELBOARD DIRECTORY CARD IN EACH PANELBOARD WITH CIRCUIT LOAD INFORMATION CLEARLY IDENTIFIED.

**CONDUCTORS:** IN SITUATIONS WHERE CONDUCTOR SIZES AND/OR QUANTITIES OF PARALLEL SETS HAVE BEEN INCREASED DUE TO VOLTAGE DROP OR FOR OTHER REASONS, CONTRACTOR SHALL PROVIDE THE APPROPRIATE LUG SIZES/QUANTITIES WITHIN THE EQUIPMENT CONNECTED (SWITCHBOARD, PANELBOARD, DISCONNECT SWITCH, TRANSFER SWITCH ETC.) TO PERMIT SATISFACTORY CONNECTION OF THE INDICATED CONDUCTORS. WHERE SUFFICIENT LUG SIZES AND/OR QUANTITIES CANNOT BE PROVIDED TO ACCOMMODATE THE CONDUCTORS INDICATED, THEN PROVIDE REDUCING ADAPTERS, PIN TERMINALS, OR A JUNCTION BOX TO SPLICE LARGER CONDUCTORS TO APPROPRIATELY SIZED SMALLER CONDUCTORS TO FIT INTO THE LUGS PROVIDED. ALL CONDUCTORS SHALL BE SIZED IN ACCORDANCE WITH THE NEC.

**<u>CONNECTION DETAILS</u>:** SECURE APPROVED SHOP DRAWINGS SHOWING WIRING DIAGRAMS, ROUGH-IN AND HOOK UP DETAILS FROM OTHER INVOLVED CONTRACTORS FOR EQUIPMENT WHICH MUST BE CONNECTED ELECTRICALLY.

#### ELECTRICAL DEMOLITION NOTES

**GENERAL:** DEMOLITION DRAWINGS ARE BASED ON EXISTING PLANS AND FIELD INVESTIGATION PRIOR TO DEMOLITION. VISIT THE EXISTING BUILDING PRIOR TO BID IN ORDER TO BECOME FAMILIAR WITH THE EXISTING CONDITIONS AND IN ORDER TO AVOID CONFLICTS.

**DASHED ITEMS:** ALL ITEMS SHOWN DASHED ON DEMOLITION PLANS ARE EXISTING AND SHALL BE REMOVED.

**SOLID ITEMS:** ALL ITEMS SHOWN SOLID ON DEMOLITION PLANS ARE EXISTING TO REMAIN.

**<u>CIRCUITING TO REMAIN:</u>** EXISTING CIRCUITING TO REMAIN SHALL BE REROUTED OR RECONNECTED, AS REQUIRED, WHERE AFFECTED BY NEW WORK IN ORDER TO MAINTAIN CONTINUITY OF THE CIRCUIT.

**EXISTING CONDUIT:** ALL EXISTING CONDUITS AND WIRING THAT WILL NOT BE REUSED SHALL BE REMOVED. ALL CONDUIT REMOVED SHALL BE REMOVED IN ITS ENTIRETY, INCLUDING FITTINGS, MOUNTING DEVICES, MOUNTING HARDWARE, ETC.

**REPAIR DAMAGE:** EXERCISE CARE IN REMOVAL OF DEMOLITION ITEMS. REPAIR, AT NO ADDITIONAL COST TO THE OWNER, ANY DAMAGE CAUSED TO EXISTING CONSTRUCTION AND/OR EQUIPMENT TO REMAIN.

**ASSOCIATED APPURTENANCES:** REMOVE ALL ELECTRICAL APPURTENANCES (DISCONNECTS, STARTERS, WIRING, CONDUIT, ETC.) ASSOCIATED WITH EQUIPMENT TO BE REMOVED BY OTHERS.

**DEMOLISHED MATERIALS:** ALL MATERIALS REMOVED UNDER DEMOLITION, NOT TO BE RELOCATED OR DESIGNATED TO BE TURNED OVER TO THE OWNER, SHALL BECOME THE PROPERTY OF THE CONTRACTOR AND SHALL BE REMOVED COMPLETELY FROM THE SITE.

**SCHEDULE OUTAGES:** ALL WORK AND ALL POWER OUTAGES ON THE EXISTING SITE SHALL BE SCHEDULED AT TIMES CONVENIENT TO THE OWNER.

**<u>NOTIFICATION:</u>** NOTIFY THE OWNER PRIOR TO TURNING OFF ANY CIRCUITS.

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# ELECTRICAL LEGEND

LIGHTING	
$\bigotimes$	GROUND MOUNTED FLOODLIGHT
0	IN-GRADE LIGHTING FIXTURE
®	PHOTOCELL, 1500W, 120V, SPST, MOUNT ON ROOF, AIM NORTH
POWER	
$\bigcirc^{\sf WP}$	WEATHERPROOF JUNCTION BOX
HH	HANDHOLE
Ţ	PAD MOUNTED TRANSFORMER
	- INDICATES FRONT
AND	ELECTRICAL CIRCUIT RUN IN CONDUIT AND CIRCUIT HOMERUN TO PANELBOARD (PANEL AND CIRCUIT DESIGNATION AS INDICATED). AS A MINIMUM CONDITION, EACH SINGLE PHASE CIRCUIT SHALL HAVE 1 #12 PHASE CONDUCTOR, 1 #12 NEUTRAL CONDUCTOR AND 1 #12 GROUNDING CONDUCTOR IN $3/4$ " CONDUIT. PROVIDE ADDITIONAL PHASE CONDUCTORS AS REQUIRED FOR "MULTIPLE PHASED" ELECTRICAL LOADS. MULTIPLE SINGLE PHASE CONDUCTORS MAY BE GROUPED TOGETHER IN A COMMON CONDUIT IN ACCORDANCE WITH THE NEC AND AT THE CONTRACTOR'S DISCRETION. GROUNDING CONDUCTORS MAY BE SHARED AS ALLOWED BY THE NEC. NEUTRAL CONDUCTORS SHALL NOT BE SHARED. MULTI–POLE BREAKERS SHALL BE PROVIDED IN ACCORDANCE WITH THE NEC SHOULD MULTI–WIRE BRANCH CIRCUITS BE INSTALLED. CONDUIT LARGER THAN $1/2$ " AND CONDUCTORS LARGER THAN #12 SHALL BE AS INDICATED.
GENERAL	
	<u>PHOTO NOTATION</u> — ENUMERATION: PHOTO NUMBER

PHOTO NOTATION — ENUMERATION: PHOTO NUMBER — SHEET WHERE PHOTO IS TAKEN — SHEET WHERE PHOTO IS SHOWN NEW WORK NOTE SYMBOL DEMOLITION NOTE SYMBOL

# ABBREVIATIONS

А	AMPERE
AFG	ABOVE FINISHED GRADE
AIC	AMPERE INTERRUPTING CAPACITY
BFG	BELOW FINISHED GRADE
С	CONDUIT
CKT	CIRCUIT
CB	CIRCUIT BREAKER
DNCP	DOMINION NORTH CAROLINA POWER
EC	EMPTY CONDUIT
ETR	EXISTING TO REMAIN
EXIST	EXISTING
GFI	GROUND FAULT INTERRUPTER
GND	GROUND
KAIC	THOUSAND AMPERE
	INTERRUPTING CAPACITY
KVA	KILO-VOLT-AMPERES
KW	KILO-WATTS
MCB	MAIN CIRCUIT BREAKER
MLO	MAIN LUGS ONLY
MTD	MOUNTED
NEC	NATIONAL ELECTRICAL CODE
NTS	NOT TO SCALE
OC	ON CENTER
Ø	PHASE
PRI	PRIMARY
REQ'D	REQUIRED
SE	SERVICE ENTRANCE
SEC	SECONDARY
TYP	TYPICAL
UON	UNLESS OTHERWISE NOTED
٧	VOLT(S)
W	WATTS/WIRE
WP	WEATHERPROOF



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Surface 678, P.A. 215 Morris Street, Suite 150 Durham, NC 27701 www.surface678.com p : 919-419-1199 f : 919-419-1669

CONSULTANTS CLEARSCAPES 311-200 W. MARTIN ST. RALEIGH, NC 27601 T: 919 821 2775 **RIGGS WARD DESIGN LC.** 2315 W MAIN ST. RICHMOND, VA 23220 T: 804 254 1740 PACE COLLABORATIVE PC. 1277 PERIMETER PKWY. VIRGINIA BEACH, VA 23454 T: 757 499 7223 REGISTRATION A GOFESSION 29538 **ENGINEEP** 

CLIENT



14094

CLUB ROAD Corolla, nc 27927

CURRITUCK COUNTY 153 COURTHOUSE ROAD, SUITE 204 CURRITUCK, NC 27929

# HISTORIC COROLLA PARK WHALEHEAD


CLUB ROAD COROLLA, NC 27927

# LANDSCAPE & PEDESTRIAN IMPROVEMENTS - PHASE I

NO.	REVISION	DATE
1	SITE PLAN RESUBMITTAL	10.16.14
2	BID FOR CONSTRUCTION	12.19.14
ISSUE:		
	STRUCTION DOC	CUMENTS
CONS	STRUCTION DOC	CUMENTS A0000
CONS		A0000
<b>CONS</b> PROJE	CT NO: DECEMBER	A0000
CONS PROJE DATE:	CT NO: DECEMBER	A0000 R 19, 2014
CONS PROJE DATE: DRAWI	CT NO: DECEMBER	A0000 R 19, 2014 WRL
CONS PROJE DATE: DRAWI CHECK	CT NO: DECEMBER	A0000 R 19, 2014 WRL
CONS PROJE DATE: DRAWI CHECK	CT NO: DECEMBER N: KED: TITLE:	A0000 R 19, 2014 WRL JWS
CONS PROJE DATE: DRAWI CHECK SHEET	CT NO: DECEMBER N: KED:	A0000 R 19, 2014 WRL JWS

**SPECIFICATIONS** 

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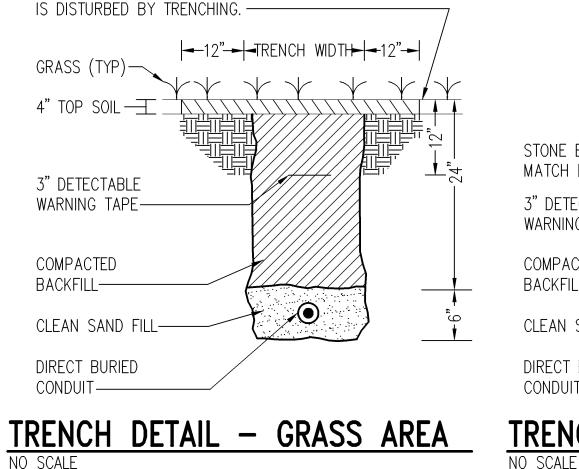
	EXISTING	PAN	IELBO	ARD	S	51 5	SCH	EDUL	E (SC	D H	С
	200A MCB, 24	40/120	VOLT, 1	PHASE,	3 WI	RE, 10 KA	IC MI	NIMUM, S	SURFACE	MOUNT	,
		LOAD	(AMPS)	BKR	СКТ	PHASE	CKT	BKR	LOAD	(AMPS)	
LOAD	SERVED	A	В	TRIP	NO.	A B	NO.	TRIP	A	B	
SOUTHEAST	TRAILER			50/2P	1	᠇᠋᠆᠇	2	30/2P			Ν
						<b>│⋏</b> <u>┤</u> →⋏					
NORTHEAST	TRAILER			30/1P	5		6	20/1P			Ś
SPARE				20/1P	7		8	20/1P		3.0	\$
NOTES:											

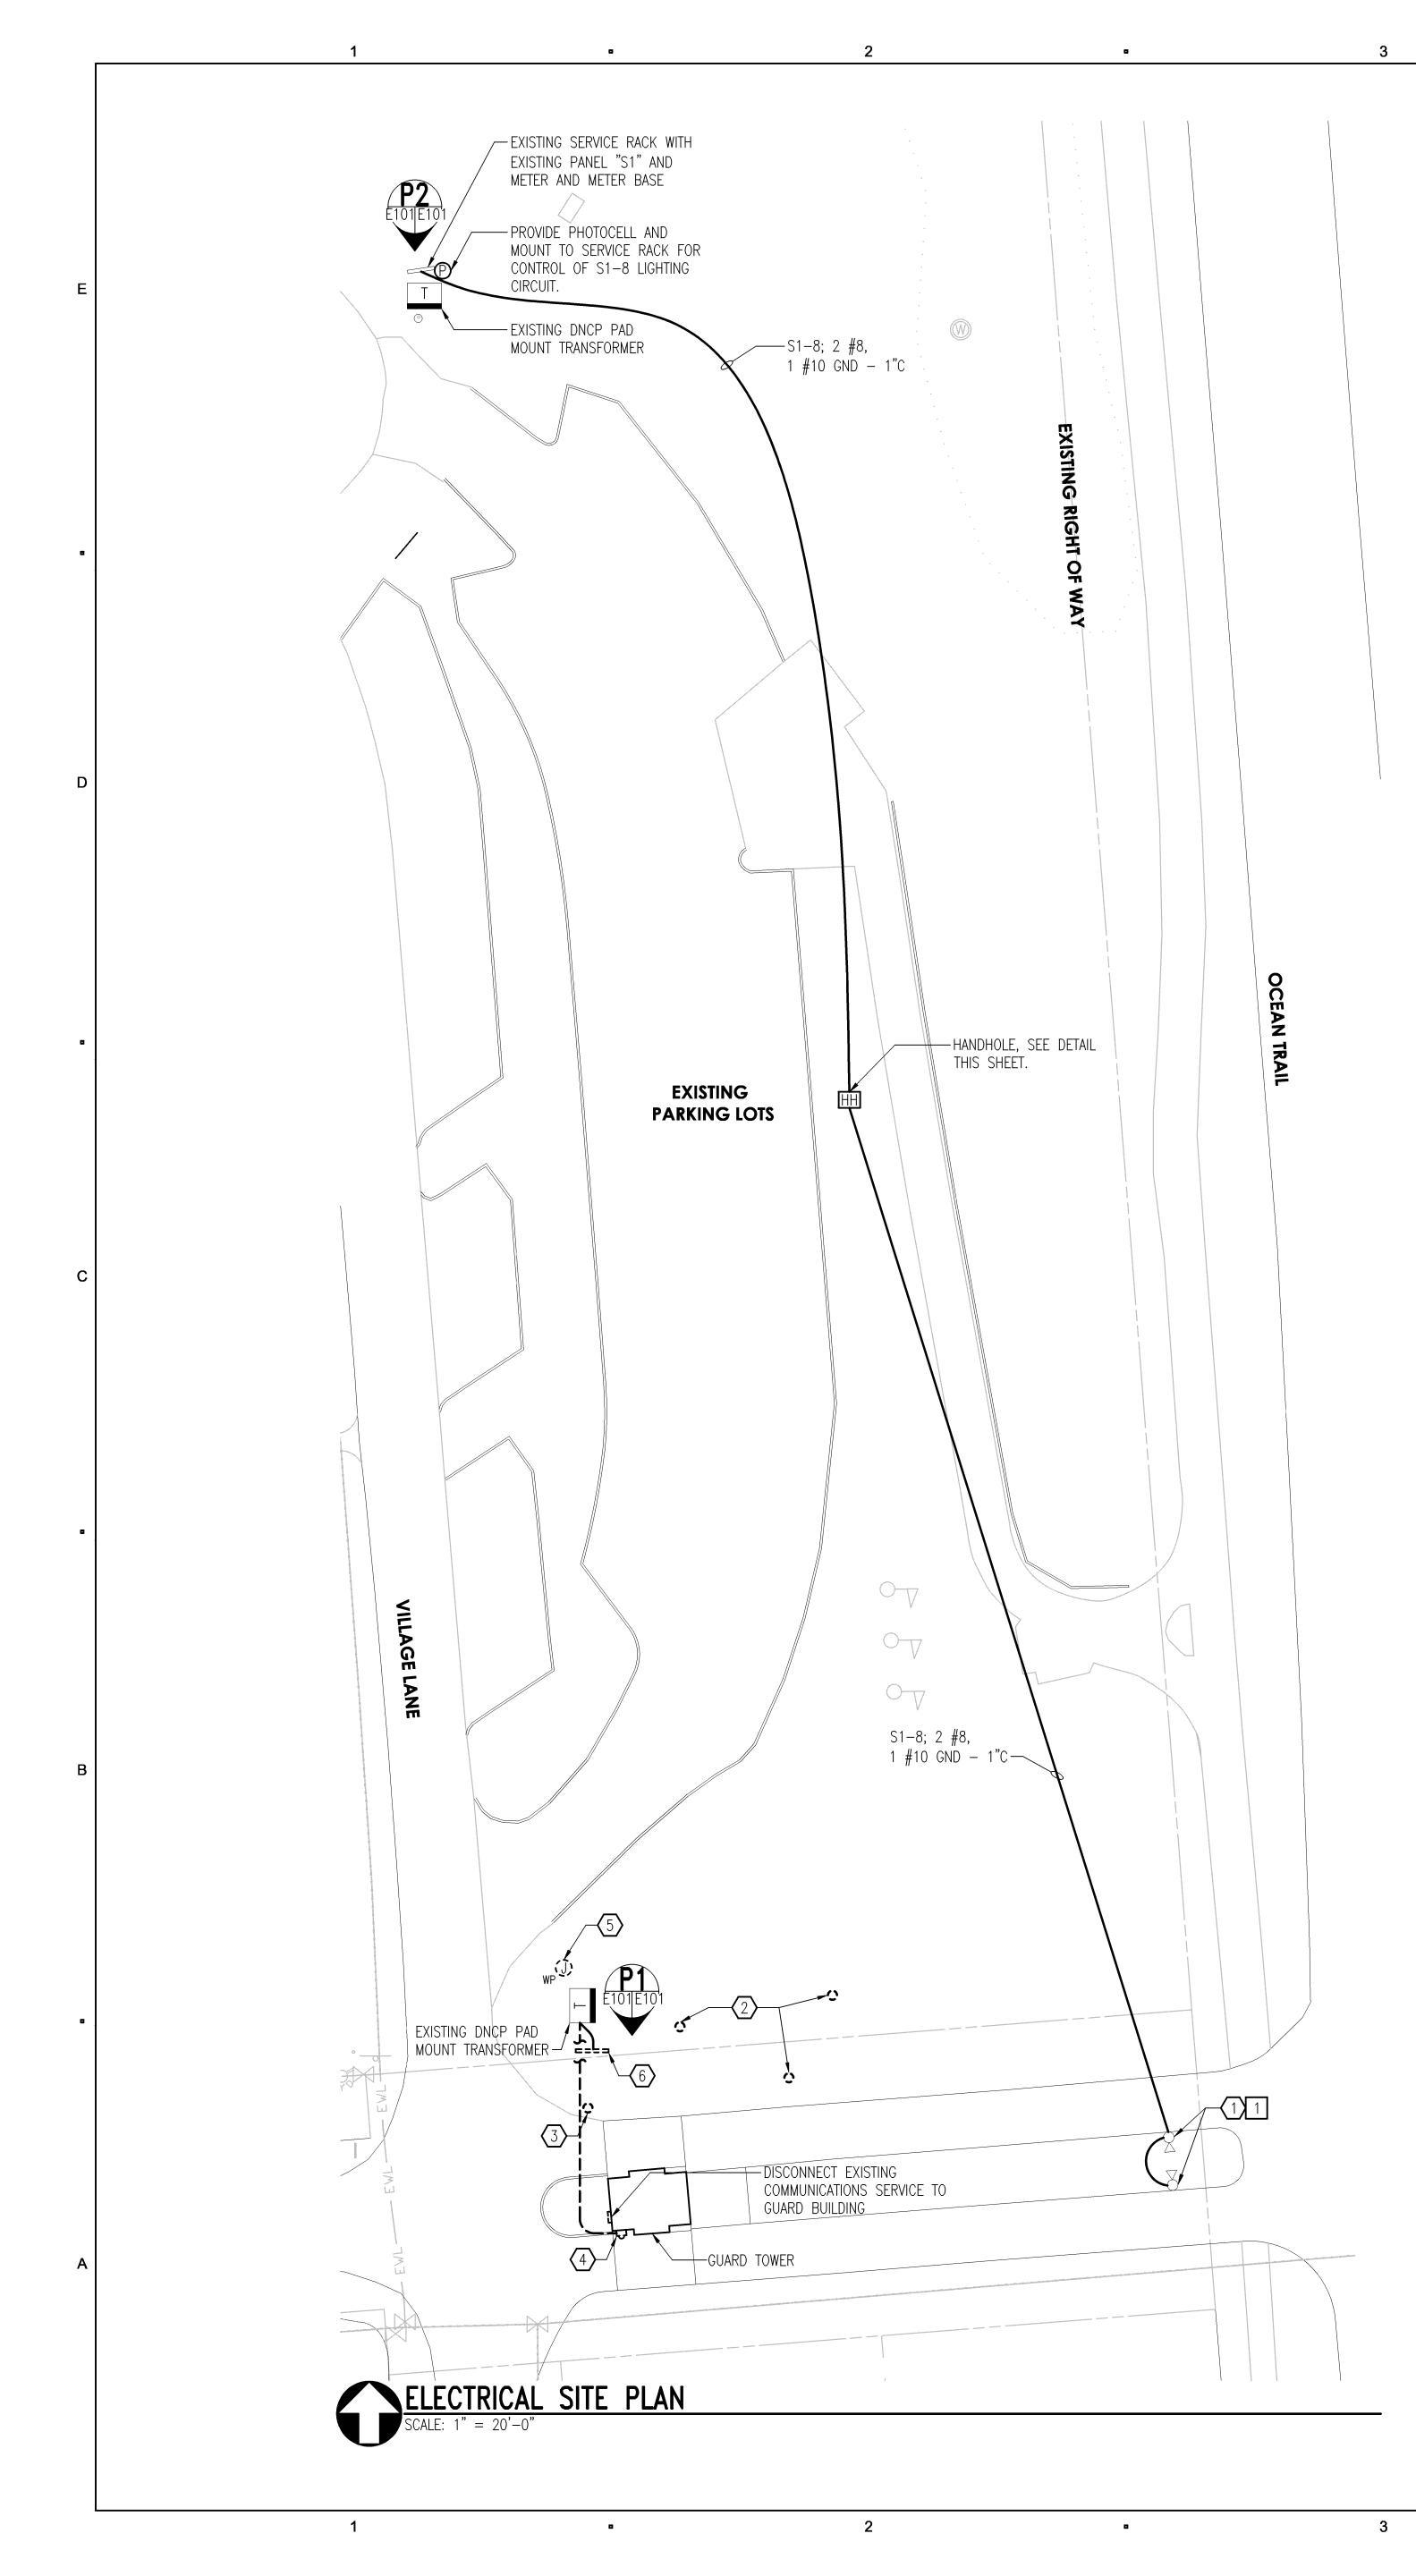4

1. PROVIDE CIRCUIT BREAKER AND CONNECT LOAD INDICATED.

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PROVIDE TOPSOIL AND RE-SEED WHERE EARTH






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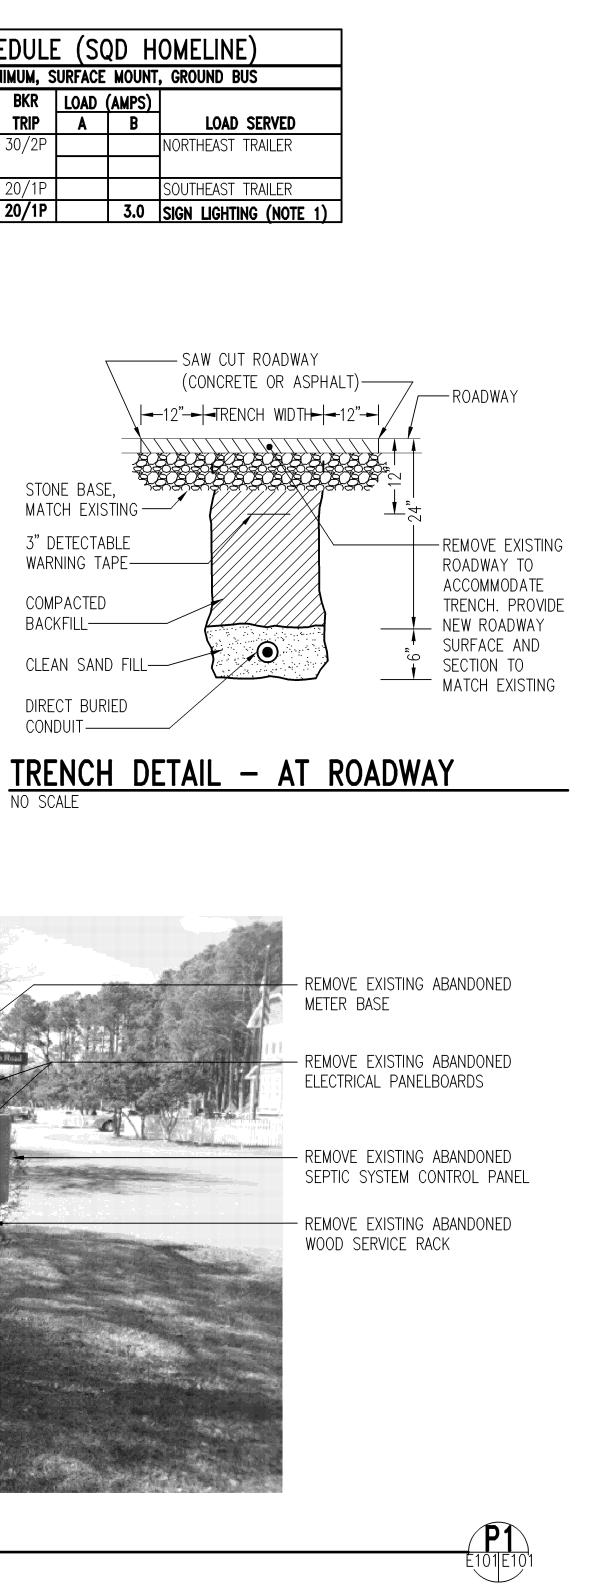
PHOTO DETAIL NO SCALE



4

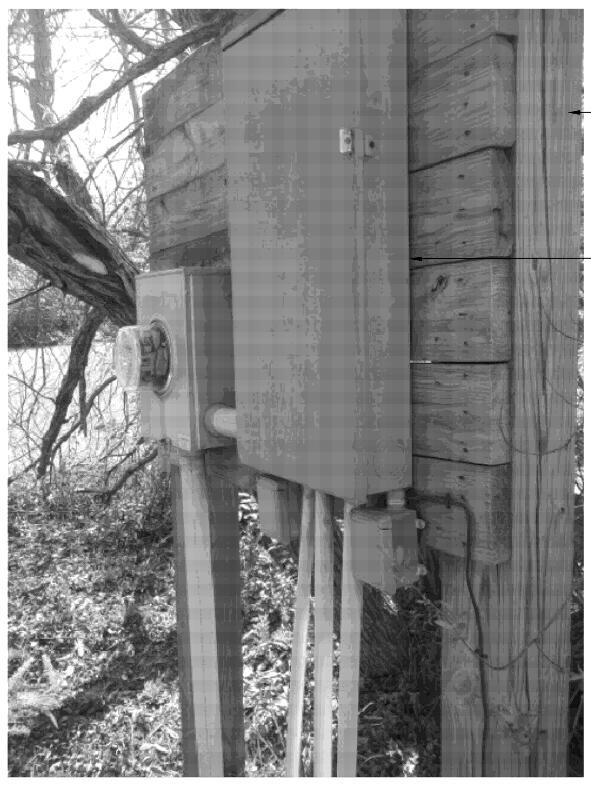PHOTO DETAIL NO SCALE

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#### - EXISTING WOOD SERVICE RACK

— EXISTING PANEL "S1"

.

## NOTES THIS SHEET


1 REMOVE EXISTING GROUND MOUNTED SIGN FLOOD LIGHT CIRCUIT FROM GUARD BUILDING AND LIGHTING FIXTURES SHALL REMAIN FOR REUSE.

6

- 2 REMOVE EXISTING ABANDONED IN-GRADE FLOOD LIGHT AND ASSOCIATED APPURTENANCES COMPLETE.
- 3 REMOVE EXISTING ABANDONED POLE BASE AND ASSOCIATED APPURTENANCES COMPLETE.
- 4 DISCONNECT EXISTING ELECTRICAL SERVICE TO METER BASE AT GUARD BUILDING AND REMOVE ELECTRICAL SECONDARY SERVICE TO DNCP PAD MOUNT TRANSFORMER. VERIFY EXACT REQUIREMENTS AND COORDINATE SERVICE DISCONNECTION AT TRANSFORMER WITH DNCP.
- $\overline{(5)}$  REMOVE EXISTING SEPTIC SYSTEM JUNCTION BOX AND ASSOCIATED APPURTENANCES COMPLETE.
- 6 REMOVE EXISTING ABANDONED SERVICE RACK, METER BASE, SEPTIC SYSTEM CONTROL PANEL AND PANELBOARDS COMPLETE.

### NOTES THIS SHEET

1 CONNECT EXISTING GROUND MOUNTED SIGN LIGHTS TO CIRCUIT INDICATED.

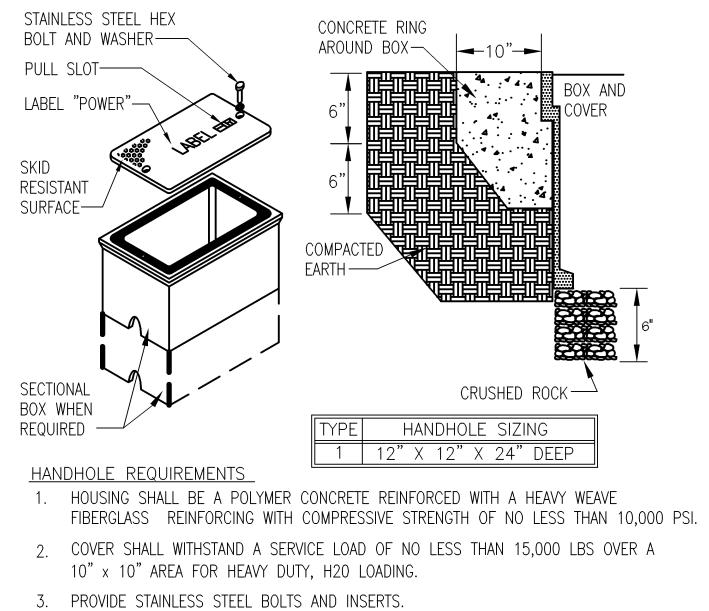

4. PROVIDE WITH (2) 2 1/2" MOUSEHOLES.

### COMPOSITE/FIBERGLASS HANDHOLE

NO SCALE

	COLLABORATIVE MECHANICAL ELECTRICAL ENGINEERS VIRGINIA BEACH, VA - 757-499-7223
<b>GRAPHIC SCALES</b>	
1" = 20' - 0"	<u>20' 40' 60'</u>

<u>P2</u>

5



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REVISION DATE NO. SITE PLAN RESUBMITTAL 10.16.14 BID FOR CONSTRUCTION 12.19.14 ISSUE: CONSTRUCTION DOCUMENTS A0000 PROJECT NO: DECEMBER 19, 2014 DATE: DRAWN: WRL CHECKED: JWS SHEET TITLE: ELECTRICAL SITE PLAN

E101